



# TOWN OF JACKSON PLANNING & BUILDING DEPARTMENT

## TRANSMITTAL MEMO

### Town of Jackson

- ☒ Public Works/Engineering
- ☒ Building
- ☐ Title Company
- ☒ Town Attorney
- ☒ Police

### Joint Town/County

- ☒ Parks and Recreation
- ☒ Pathways
- ☒ Joint Housing Dept

### Teton County

- ☐ Planning Division

- ☐ Engineer
- ☐ Surveyor- *Nelson*
- ☐ Assessor
- ☐ Clerk and Recorder
- ☐ Road and Levee

### State of Wyoming

- ☐ Teton Conservation
- ☐ WYDOT
- ☐ TC School District #1
- ☐ Game and Fish
- ☐ DEQ

### Federal Agencies

- ☐ Army Corp of Engineers

### Utility Providers

- ☐ Qwest
- ☐ Lower Valley Energy
- ☐ Bresnan Communications

### Special Districts

- ☒ START
- ☒ Jackson Hole Fire/EMS
- ☐ Irrigation Company

<p>Date: May 4, 2023</p> <p>Item #: P23-085</p> <hr/> <p>Planner: Katelyn Page</p> <p>Phone: 733-0440 ext. 1302</p> <p>Email: <a href="mailto:kpage@jacksonwy.gov">kpage@jacksonwy.gov</a></p> <hr/> <p><b>Owner</b> Teton Gables, LLC PO Box 6467 Jackson, WY 83002</p> <p><b>Applicant</b> Grace Spa PO Box 2117 Jackson, WY 83001</p>	<p style="text-align: center;">REQUESTS:</p> <p>The applicant is submitting a request for a Basic Use Permit for the property located at 155 W. Gill Ave, Ste 108, legally known as LOTS 8, 9, &amp; 10, BLK. 1, ORIGINAL TOWNSITE, TOWN OF JACKSON PIDN: 22-41-16-28-4-06-011</p> <p>For questions, please call Katelyn Page at 733-0440, x1302 or send an email to the address shown below. Thank you.</p>
<p><b>Please respond by: May 18, 2023 (Sufficiency)</b> <b>May 25, 2023 (with Comments)</b></p>	

**RESPONSE:** For Departments not using SmartGov, please send responses via email to:  
[planning@jacksonwy.gov](mailto:planning@jacksonwy.gov)

April 17, 2023

Katelyn S. Page  
Associate Planner  
Town of Jackson  
PO Box 1687  
Jackson, WY 83001

RE: Project Narrative for grace spa, 155 West Gill Avenue, Suite 108 – Basic Use Permit

Dear Katelyn:

The following is a "project narrative" in response to your recent request for the Basic Use Permit for Grace Spa.

The Spa has been in business since March, 2015 and formerly located at 55 E. Pearl Street, Jackson, WY. The Pearl Street location was purchased by Crystal Creek Capital and the lease was terminated. The Spa found a new location at 155 West Gill Street, Suite 108. The interior of the space was renovated to accommodate the Spa needs and all building permits were submitted and approved.

Employees – We do not have any employees. We pay commission based independent contractors. We currently use 8 independent contractors and the number has not changed from our prior location.

Hours - Our hours of use are Monday-Friday 9:30am-5:30pm, occasional Saturday appointments and Sunday - closed.

Typical operations of the spa encounter 2-5 patrons at a time who will be in the building for 1-2 hours for services such as: hair color/cut, pedicure, manicure, facial, massage and waxing.


Parking – Independent Contractors utilize 2-5 parking spots for anywhere from 2-8 hours in a typical day on public streets. Patrons will utilize the 25 plus shared spots on site and public street parking for 2-5 spots rotating on average 1-2 hours per visit.

Affordable Housing – We have Independent Contractors that have adequate, stable housing either through ownership or rental situations. Please see our Housing Mitigation Plan checklist attached.

It is my understanding that you will review "The Basic Use Permit" application and then notify me. I look forward to your review results. Please feel free to phone me at 307-413-5631 c. with any questions or requests for additional information.

Thank you,

Sincerely,

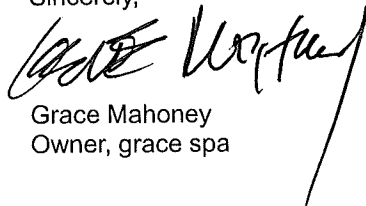

Grace Mahoney  
Owner, grace spa



**PLANNING PERMIT APPLICATION**  
**Planning & Building Department**

150 E Pearl Ave. | ph: (307) 733-0440  
P.O. Box 1687 | [www.townofjackson.com](http://www.townofjackson.com)  
Jackson, WY 83001

**For Office Use Only**

Fees Paid \_\_\_\_\_ Date & Time Received \_\_\_\_\_  
Application #s \_\_\_\_\_

**Please note:** Applications received after 3 PM will be processed the next business day.

**PROJECT.**

Name/Description: \_\_\_\_\_  
Physical Address: \_\_\_\_\_  
Lot, Subdivision: \_\_\_\_\_ PIDN: \_\_\_\_\_

**PROPERTY OWNER.**

Name: \_\_\_\_\_ Phone: \_\_\_\_\_  
Mailing Address: \_\_\_\_\_ ZIP: \_\_\_\_\_  
E-mail: \_\_\_\_\_

**APPLICANT/AGENT.**

Name: \_\_\_\_\_ Phone: \_\_\_\_\_  
Mailing Address: \_\_\_\_\_ ZIP: \_\_\_\_\_  
E-mail: \_\_\_\_\_

**DESIGNATED PRIMARY CONTACT.**

\_\_\_\_\_ Property Owner \_\_\_\_\_ Applicant/Agent

**TYPE OF APPLICATION.** Please check all that apply; review the type of application at [www.townofjackson/200/Planning](http://www.townofjackson/200/Planning)

**Use Permit**

\_\_\_\_\_ Basic Use  
\_\_\_\_\_ Conditional Use  
\_\_\_\_\_ Special Use

**Relief from the LDRs**

\_\_\_\_\_ Administrative Adjustment  
\_\_\_\_\_ Variance  
\_\_\_\_\_ Beneficial Use Determination  
\_\_\_\_\_ Appeal of an Admin. Decision

**Physical Development**

\_\_\_\_\_ Sketch Plan  
\_\_\_\_\_ Development Plan  
\_\_\_\_\_ Design Review

**Subdivision/Development Option**

\_\_\_\_\_ Subdivision Plat  
\_\_\_\_\_ Boundary Adjustment (replat)  
\_\_\_\_\_ Boundary Adjustment (no plat)  
\_\_\_\_\_ Development Option Plan

**Interpretations**

\_\_\_\_\_ Formal Interpretation  
\_\_\_\_\_ Zoning Compliance Verification

**Amendments to the LDRs**

\_\_\_\_\_ LDR Text Amendment  
\_\_\_\_\_ Map Amendment

**Miscellaneous**

\_\_\_\_\_ Other: \_\_\_\_\_  
\_\_\_\_\_ Environmental Analysis

**PRE-SUBMITTAL STEPS.** To see if pre-submittal steps apply to you, go to [www.townofjackson.com/200/Planning](http://www.townofjackson.com/200/Planning) and select the relevant application type for requirements. Please submit all required pre-submittal steps with application.

Pre-application Conference #: \_\_\_\_\_ Environmental Analysis #: \_\_\_\_\_  
Original Permit #: \_\_\_\_\_ Date of Neighborhood Meeting: \_\_\_\_\_

**SUBMITTAL REQUIREMENTS.** Please ensure all submittal requirements are included. The Planning Department will not hold or process incomplete applications. Partial or incomplete applications will be returned to the applicant. Go to [www.townofjackson.com/200/Planning](http://www.townofjackson.com/200/Planning) and select the relevant application type for submittal requirements.

Have you attached the following?


\_\_\_\_\_ **Application Fee.** Fees are cumulative. Go to [www.townofjackson.com/200/Planning](http://www.townofjackson.com/200/Planning) and select the relevant application type for the fees.


\_\_\_\_\_ **Notarized Letter of Authorization.** A notarized letter of consent from the landowner is required if the applicant is not the owner, or if an agent is applying on behalf of the landowner. Please see the Letter of Authorization template at <http://www.townofjackson.com/DocumentCenter/View/845/LetterOfAuthorization-PDF>.

\_\_\_\_\_ **Response to Submittal Requirements.** The submittal requirements can be found on the TOJ website for the specific application. If a pre-application conference is required, the submittal requirements will be provided to applicant at the conference. The submittal requirements are at [www.townofjackson.com/200/Planning](http://www.townofjackson.com/200/Planning) under the relevant application type.

**Note:** Information provided by the applicant or other review agencies during the planning process may identify other requirements that were not evident at the time of application submittal or a Pre-Application Conference, if held. Staff may request additional materials during review as needed to determine compliance with the LDRs.

Under penalty of perjury, I hereby certify that I have read this application and associated checklists and state that, to the best of my knowledge, all information submitted in this request is true and correct. I agree to comply with all county and state laws relating to the subject matter of this application, and hereby authorize representatives of Teton County to enter upon the above-mentioned property during normal business hours, after making a reasonable effort to contact the owner/applicant prior to entering.

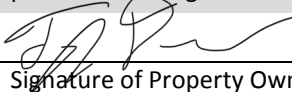  
\_\_\_\_\_  
Signature of Property Owner or Authorized Applicant/Agent

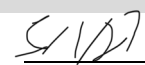  
\_\_\_\_\_  
Date

\_\_\_\_\_  
Name Printed

\_\_\_\_\_  
Title





Town of Jackson  
150 E Pearl Avenue  
PO Box 1687, Jackson, WY 83001  
P: (307)733-3932 F: (307)739-0919  
www.jacksonwy.gov

Date: 4/18/2023

# LETTER OF AUTHORIZATION NAMING APPLICANT AS OWNER'S AGENT

**PRINT** full name of property owner as listed on the deed when it is an individual OR print full name and title of President or Principal Officer when the owner listed on the deed is a corporation or an entity other than an individual

Being duly sworn, deposes and says that Teton Gables LLC is the owner in fee of the premises located at:

Name of property owner as listed on deed

Address of Premises: 155 W. Gill Avenue, Suite 108

Legal Description: Lots 8, 9 & 10, Block 1, Original Town Site, TOJ

Please attach additional sheet for additional addresses and legal descriptions

And, that the person named as follows: Name of Applicant/agent: grace spa, Grace Mahoney

Mailing address of Applicant/agent: PO Box 2117, Jackson, WY 83001

Email address of Applicant/agent: grace@gracespajh.com

Phone Number of Applicant/agent: 307-201-1888

Is authorized to act as property owner's agent and be the applicant for the application(s) checked below for a permit to perform the work specified is this(these) application(s) at the premises listed above:

- ☐ Development/Subdivision Plat Permit Application ☐ Building Permit Application  
☐ Public Right of Way Permit ☐ Grading and Erosion Control Permit ☒ Business License Application  
☐ Demolition Permit ☐ Home Occupation ☒ Other (describe) Basic Use Permit

Under penalty of perjury, the undersigned swears that the foregoing is true and, if signing on behalf of a corporation, partnership, limited liability company or other entity, the undersigned swears that this authorization is given with the appropriate approval of such entity, if required.

Property Owner Signature  
Owner / Organizer

Title if signed by officer, partner or member of corporation, LLC (secretary or corporate owner) partnership or other non-individual Owner

STATE OF Wyoming )  
 ) SS.  
COUNTY OF Teton )



The foregoing instrument was acknowledged before me by Tyler Davis this 18<sup>th</sup> day of April 2023. WITNESS my hand and official seal.

Notary Public

My commission expires: June 16<sup>th</sup>, 2024

Development of a new house, hotel, or commercial space generates the need for employees. The construction workforce builds the space, the commercial workforce or residential service workforce works in the space, and first responders are needed to protect the space. Only about 27% of the employees generated by development can afford housing in the community, but the community's "community first" character goal is that 65% of employees live locally. To bridge this affordability gap, each development is required to include affordable workforce housing proportional to the employees it generates. These housing mitigation requirements are established in Division 6.3 of the Land Development Regulations. This worksheet is intended to assist in meeting the requirements for a project. However, an error in the worksheet does not amend the actual standard; if you find an error please notify the Planning Department. Fill in the highlighted cells, all the other cells will autopopulate.

Calculating the Requirement (Sec. 6.3.2 & 6.3.3)

Step 1: Location

Town of Jackson

The applicable regulations vary by jurisdiction please identify the location of your project using the above dropdown options.

The required housing is based on the existing and proposed use of the site. Step 2 is to enter the existing use and Step 3 is to enter the proposed use. Section 6.3.2 of the LDRs establishes the applicability of the affordable workforce housing standards and Section 6.3.3 establishes the specifics on calculation of the requirement. Enter each use in its own row, add rows if needed. If a building has multiple units with the same use, describe each unit in its own row. (For example: if a duplex is composed of a 2,300 sf attached unit and a 1,700 sf attached unit, put each unit in its own row do not put in 4,000 sf of attached single-family.) If a unit type (e.g. apartment floor plan, or commercial tenant space) is replicated exactly multiple times, you may use the "Use Quantity" column to avoid adding multiple rows.

Step 2: Existing Development

Housing is only required for new development. Please describe the existing use of the site so that it can be credited from the housing requirement. The definition of existing use is Section 6.3.2.A.1 of the LDRs. Generally, the existing use to enter is the use with the highest housing requirement that either existed in 1995, or has been permitted since 1995. Please attach proof of existence.

Existing Use (Sec. 6.3.2.A)	Housing Requirement (Sec. 6.3.3.A)	Use Size: bedrooms	Use Size: habitable sf	Use Quantity	Housing Required
Service	0.000216*sf	0	1748	1	0.377
Existing Workforce Housing Credit					0.377

Step 3: Proposed Development

Please describe the proposed use of the site to determine if affordable workforce housing is required as part of the development. Describe the end result of the proposed development. (For example: in the case of an addition do not enter the square footage of the addition, enter the size of the unit upon completion of the addition.)

Proposed Use	Housing Requirement (Sec. 6.3.3.A)	Use Size: bedrooms	Use Size: habitable sf	Use Quantity	Housing Required
service	0.000216*sf	0	1748	1	0.377

Affordable Workforce Housing Required:

0.000 units

Fee-in-Lieu Amount: \$

-

If the amount of required affordable workforce housing is less than one unit, you may pay the above fee in-lieu of providing the required housing. If you elect to pay the fee, your Housing Mitgation Plan is complete. If the requirement is greater than one unit, or you would like to provide a unit to meet the requirement, please proceed to the [Unit Type Sheet](#).



GRACE SPA INTERIOR REMODEL

155 WEST GILL AVE, JACKSON WYOMING, 83001

ISSUE FOR PERMIT CORRECTIONS

TOWN OF JACKSON  
APPROVED FOR BUILDING CONSTRUCTION. ANY DEVIATIONS FROM APPROVED PLANS  
ARE SUBJECT TO PRIOR APPROVAL. APPROVAL OF THESE PLANS DOES NOT RELIEVE  
THE DESIGN PROFESSIONAL, GENERAL CONTRACTOR OR SUBMITTER OF ANY  
RESPONSIBILITY FOR COMPLIANCE WITH STATE AND LOCAL BUILDING CODES.  
AN APPROVED SET OF THESE PLANS IS TO BE AVAILABLE ON THE JOB SITE FOR USE  
BY INSPECTORS. IF SUCH PLANS ARE NOT AVAILABLE ON SITE, ANY INSPECTION MAY  
BE CANCELLED AND A REINSPECTION CHARGE LEVIED PER TOWNSHIP ORDINANCE  
BEING PERFORMED.  
PERMIT NO: B22-0606  
DATE: 10-10-22  
BUILDING OFFICIAL: KS

10.05.2022

SCOPE OF WORK	PROJECT DATA	APPLICABLE CODES BY JURISDICTION
1. 1,748 SF OF SPA BUILD OUT AND TENANT IMPROVEMENTS AT 155 W GILL AVENUE 2. PLUMBING AT CRAWLSPACE	BUILDING OCCUPANCY CLASSIFICATION B BUSINESS BUILDING CONSTRUCTION TYPE TYPE V-B ORDINARY NUMBER OF STORIES 1 NUMBER OF DWELLING UNITS 0 ZONING DISTRICT CR-2 PROPERTY INDEX NUMBER 22-41-16-28-4-06-011	ZONING CODE TOJ LAND DEVELOPMENT REGULATIONS, LATEST EDITION BUILDING CODE 2021 IRC WITH LOCAL AMENDMENTS, LATEST EDITION ENERGY CODE 2021 IECC WITH LOCAL AMENDMENTS MECHANICAL CODE 2021 IMC WITH LOCAL AMENDMENTS ELECTRICAL CODE 2021 NEC WITH LOCAL AMENDMENTS PLUMBING CODE 2021 IPC WITH LOCAL AMENDMENTS ACCESSIBILITY CODE 2017 ICC A117.1 FIRE PROTECTION CODE 2021 IFC WITH LOCAL AMENDMENTS WILDLIFE 2021 ICC WUIC
<div><div><div><div>EXISTING 1,748 SFSPACE</div><div>NOT IN SCOPE</div></div><div>1 KEYPLAN N.T.S.</div></div><div><div>COVER SHEET G0.0 GENERAL NOTES A1.00 EXISTING PLANS D1.00 DEMOLITION PLANS A1.01 PROPOSED PLAN A1.02 REFLECTED CEILING PLANS/ELECTRICAL A2.00 INTERIOR ELEVATIONS A8.00 SCHEDULES AND DIAGRAMS M0.1 NOTES, LEGEND, ABBREVIATIONS M0.2 MECHANICAL SPECIFICATIONS M0.3 MECHANICAL SPECIFICATIONS M0.4 MECHANICAL SPECIFICATIONS M0.5 SCHEDULES M0.6 DETAILS M1.0 FIRST FLOOR MECHANICAL PLAN P1.0 BASEMENT DOMESTIC PLUMBING PLAN P1.1 FIRST FLOOR DOMESTIC PLUMBING PLAN P1.2 BASEMENT SANITARY PLUMBING PLAN P1.3 FIRST FLOOR SANITARY PLUMBING PLAN E0.00 ELECTRICAL COVER SHEET ED1.00 ELECTRICAL DEMO PLAN E0.01 LIGHTING COMPLIANCE E1.00 LIGHTING PLAN E2.00 POWER PLAN E2.01 MECHANICAL POWER PLAN E3.00 SINGLE LINE DIAGRAM E4.00 EXISTING PANEL SCHEDULES E5.00 DETAILS</div></div></div>		






AREA MAP	PROJECT TEAM MEMBERS	PROFESSIONAL CERTIFICATIONS
	TENANT GRACE MAHONEY	<div></div>
	ARCHITECT NORTHWORKS ARCHITECTS & PLANNERS 185 E Hansen Ave Jackson, Wyoming 83001	
	MEP ENGINEER TATE COLBERT 23 Mathew Avenue Burlington VT 05408	
	GENERAL CONTRACTOR WEST FORK CONSTRUCTION 240 E Hansen Ave, Jackson, WY 83001	
		<div><div>NORTHWORKS</div><div>185 E. HANSEN AVE P.O. BOX 4027 JACKSON HOLE, WY 83001 T: 307-201-5324</div></div>



</

[illegible]



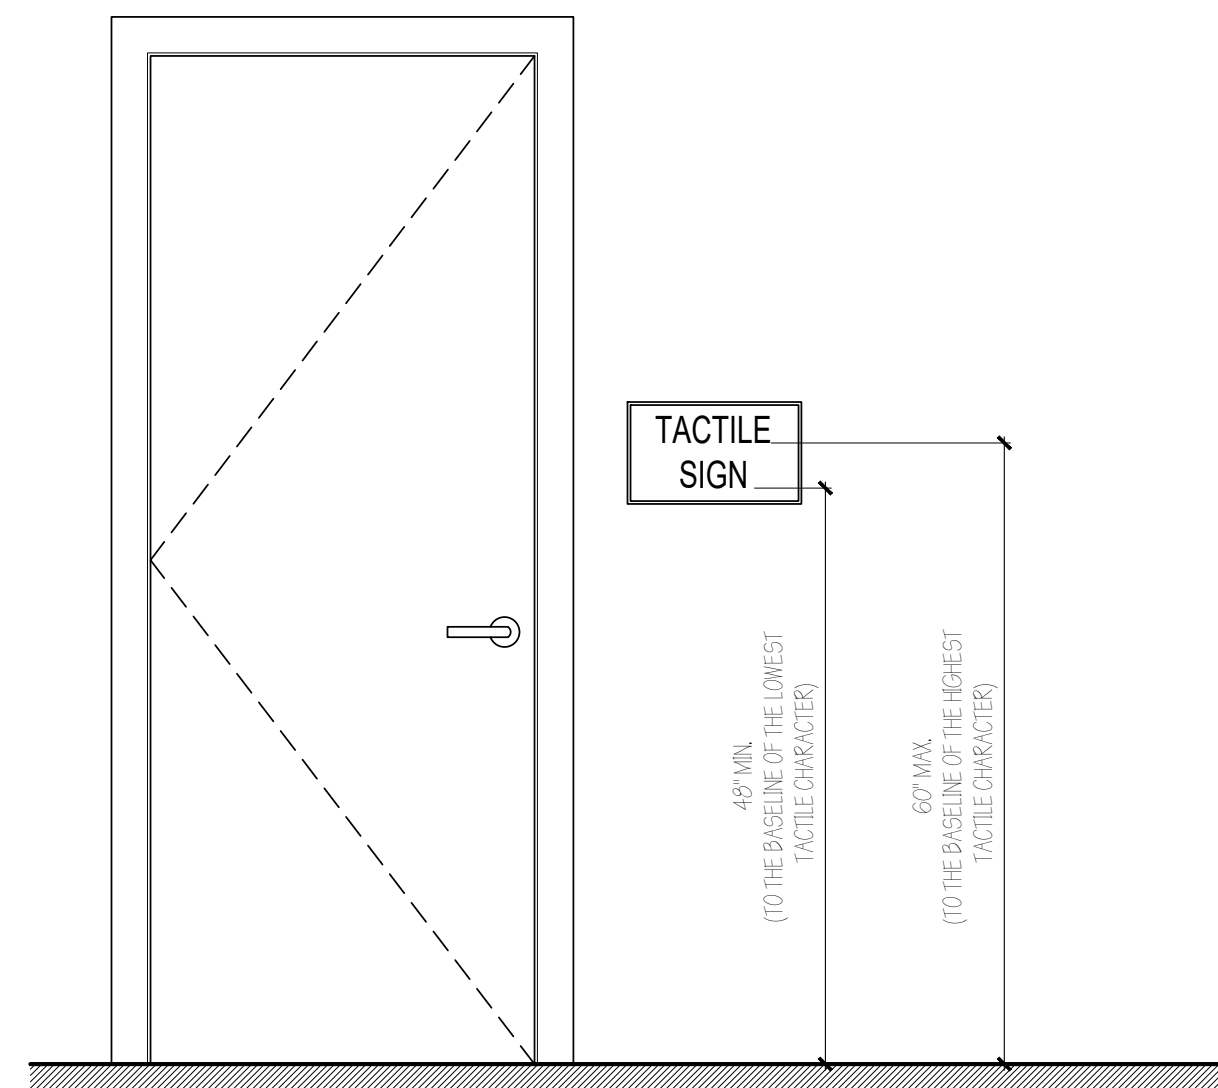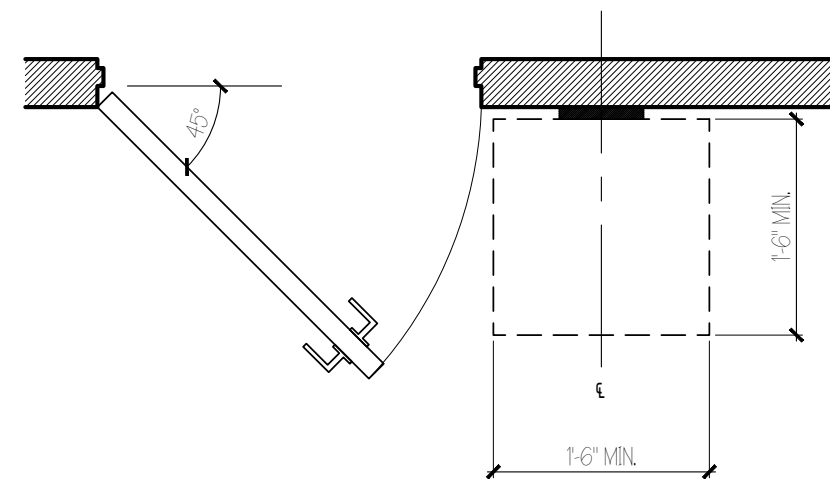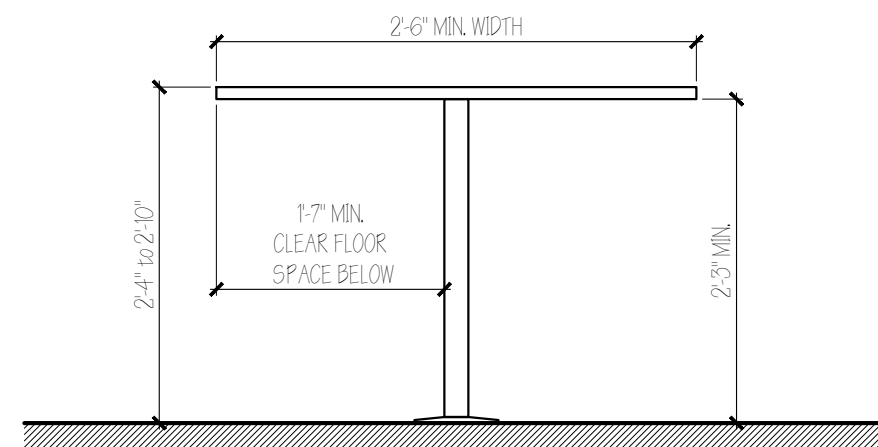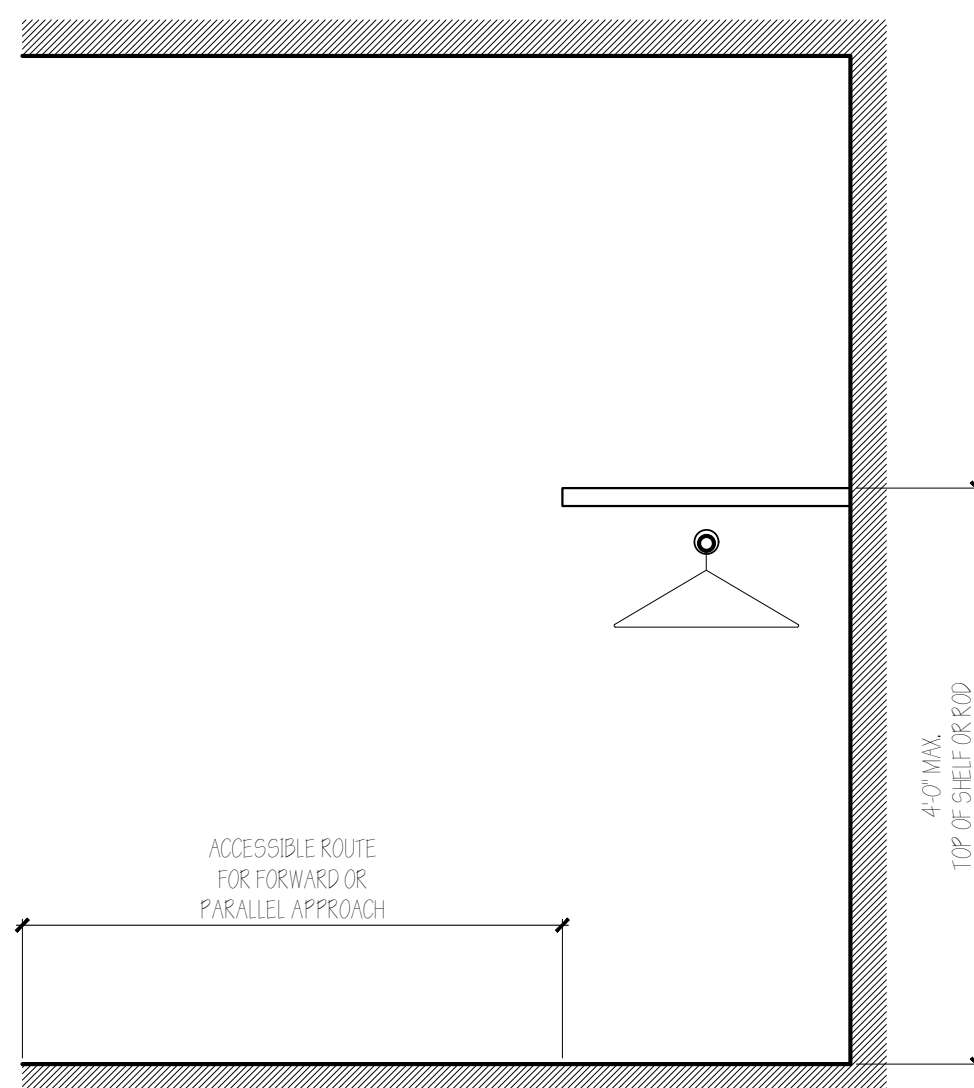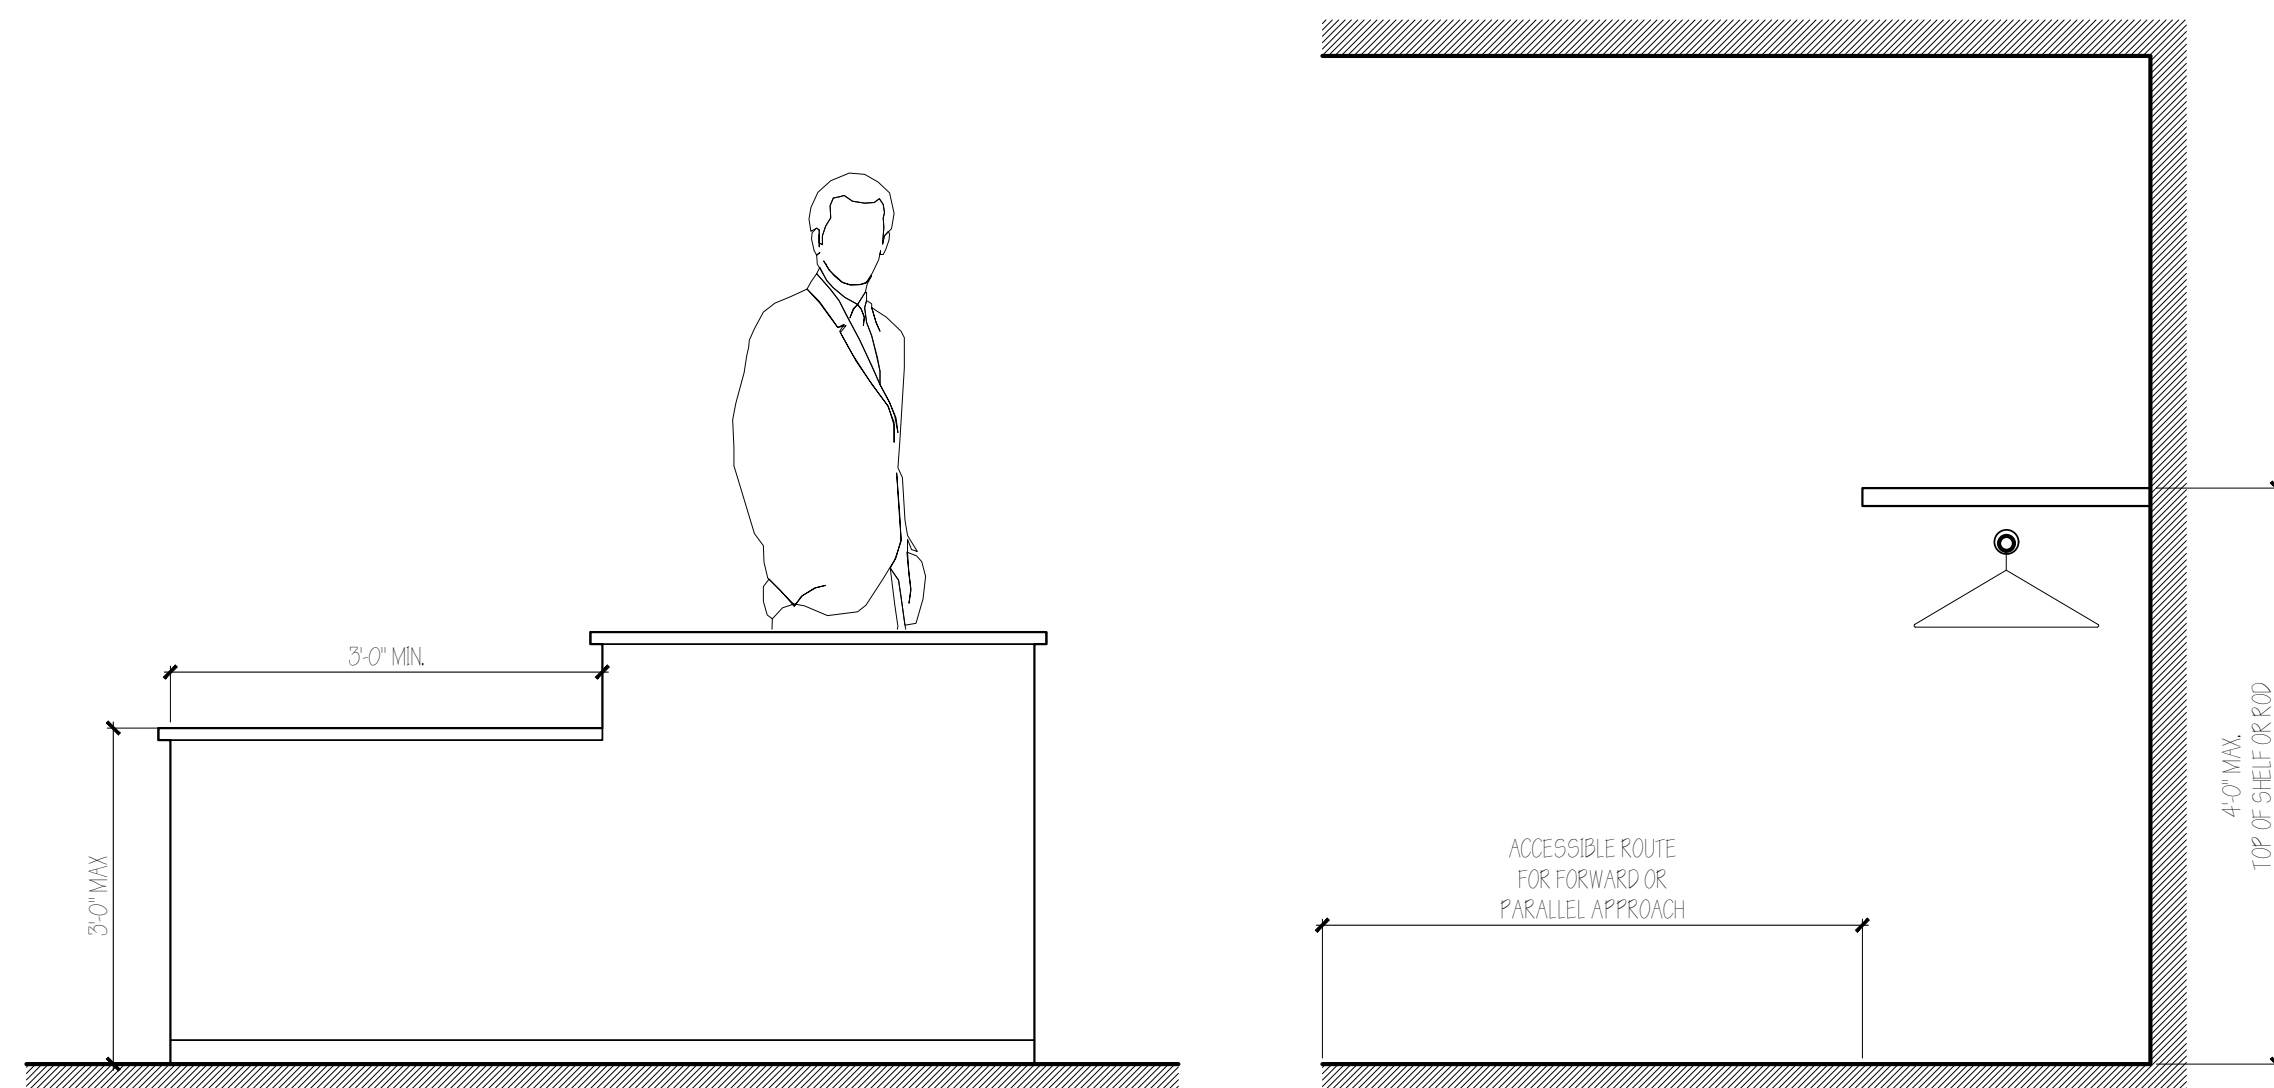

APPROVED FOR BUILDING CONSTRUCTION. ANY DEVIATIONS FROM APPROVED PLANS  
 ARE SUBJECT TO PRIOR APPROVAL. APPROVAL OF THESE PLANS DOES NOT RELIEVE  
 THE DESIGN PROFESSIONAL OF GENERAL RESPONSIBILITY FOR THE PROJECT. THE  
 DESIGN PROFESSIONAL SHALL BE RESPONSIBLE FOR COMPLIANCE WITH ALL CITY ORDINANCES.  
 AN APPROVED SET OF THESE PLANS IS NOT AVAILABLE ON SITE. ANY INSPECTION MAY  
 BE CANCELLED AND A REINSPECTION OF THE PROJECT REQUIRED TO THE INSPECTION  
 BEING PERFORMED.  
 PERMIT NO. 022-0606  
 DATE: 10-10-22  
 BUILDING OFFICIAL: KS

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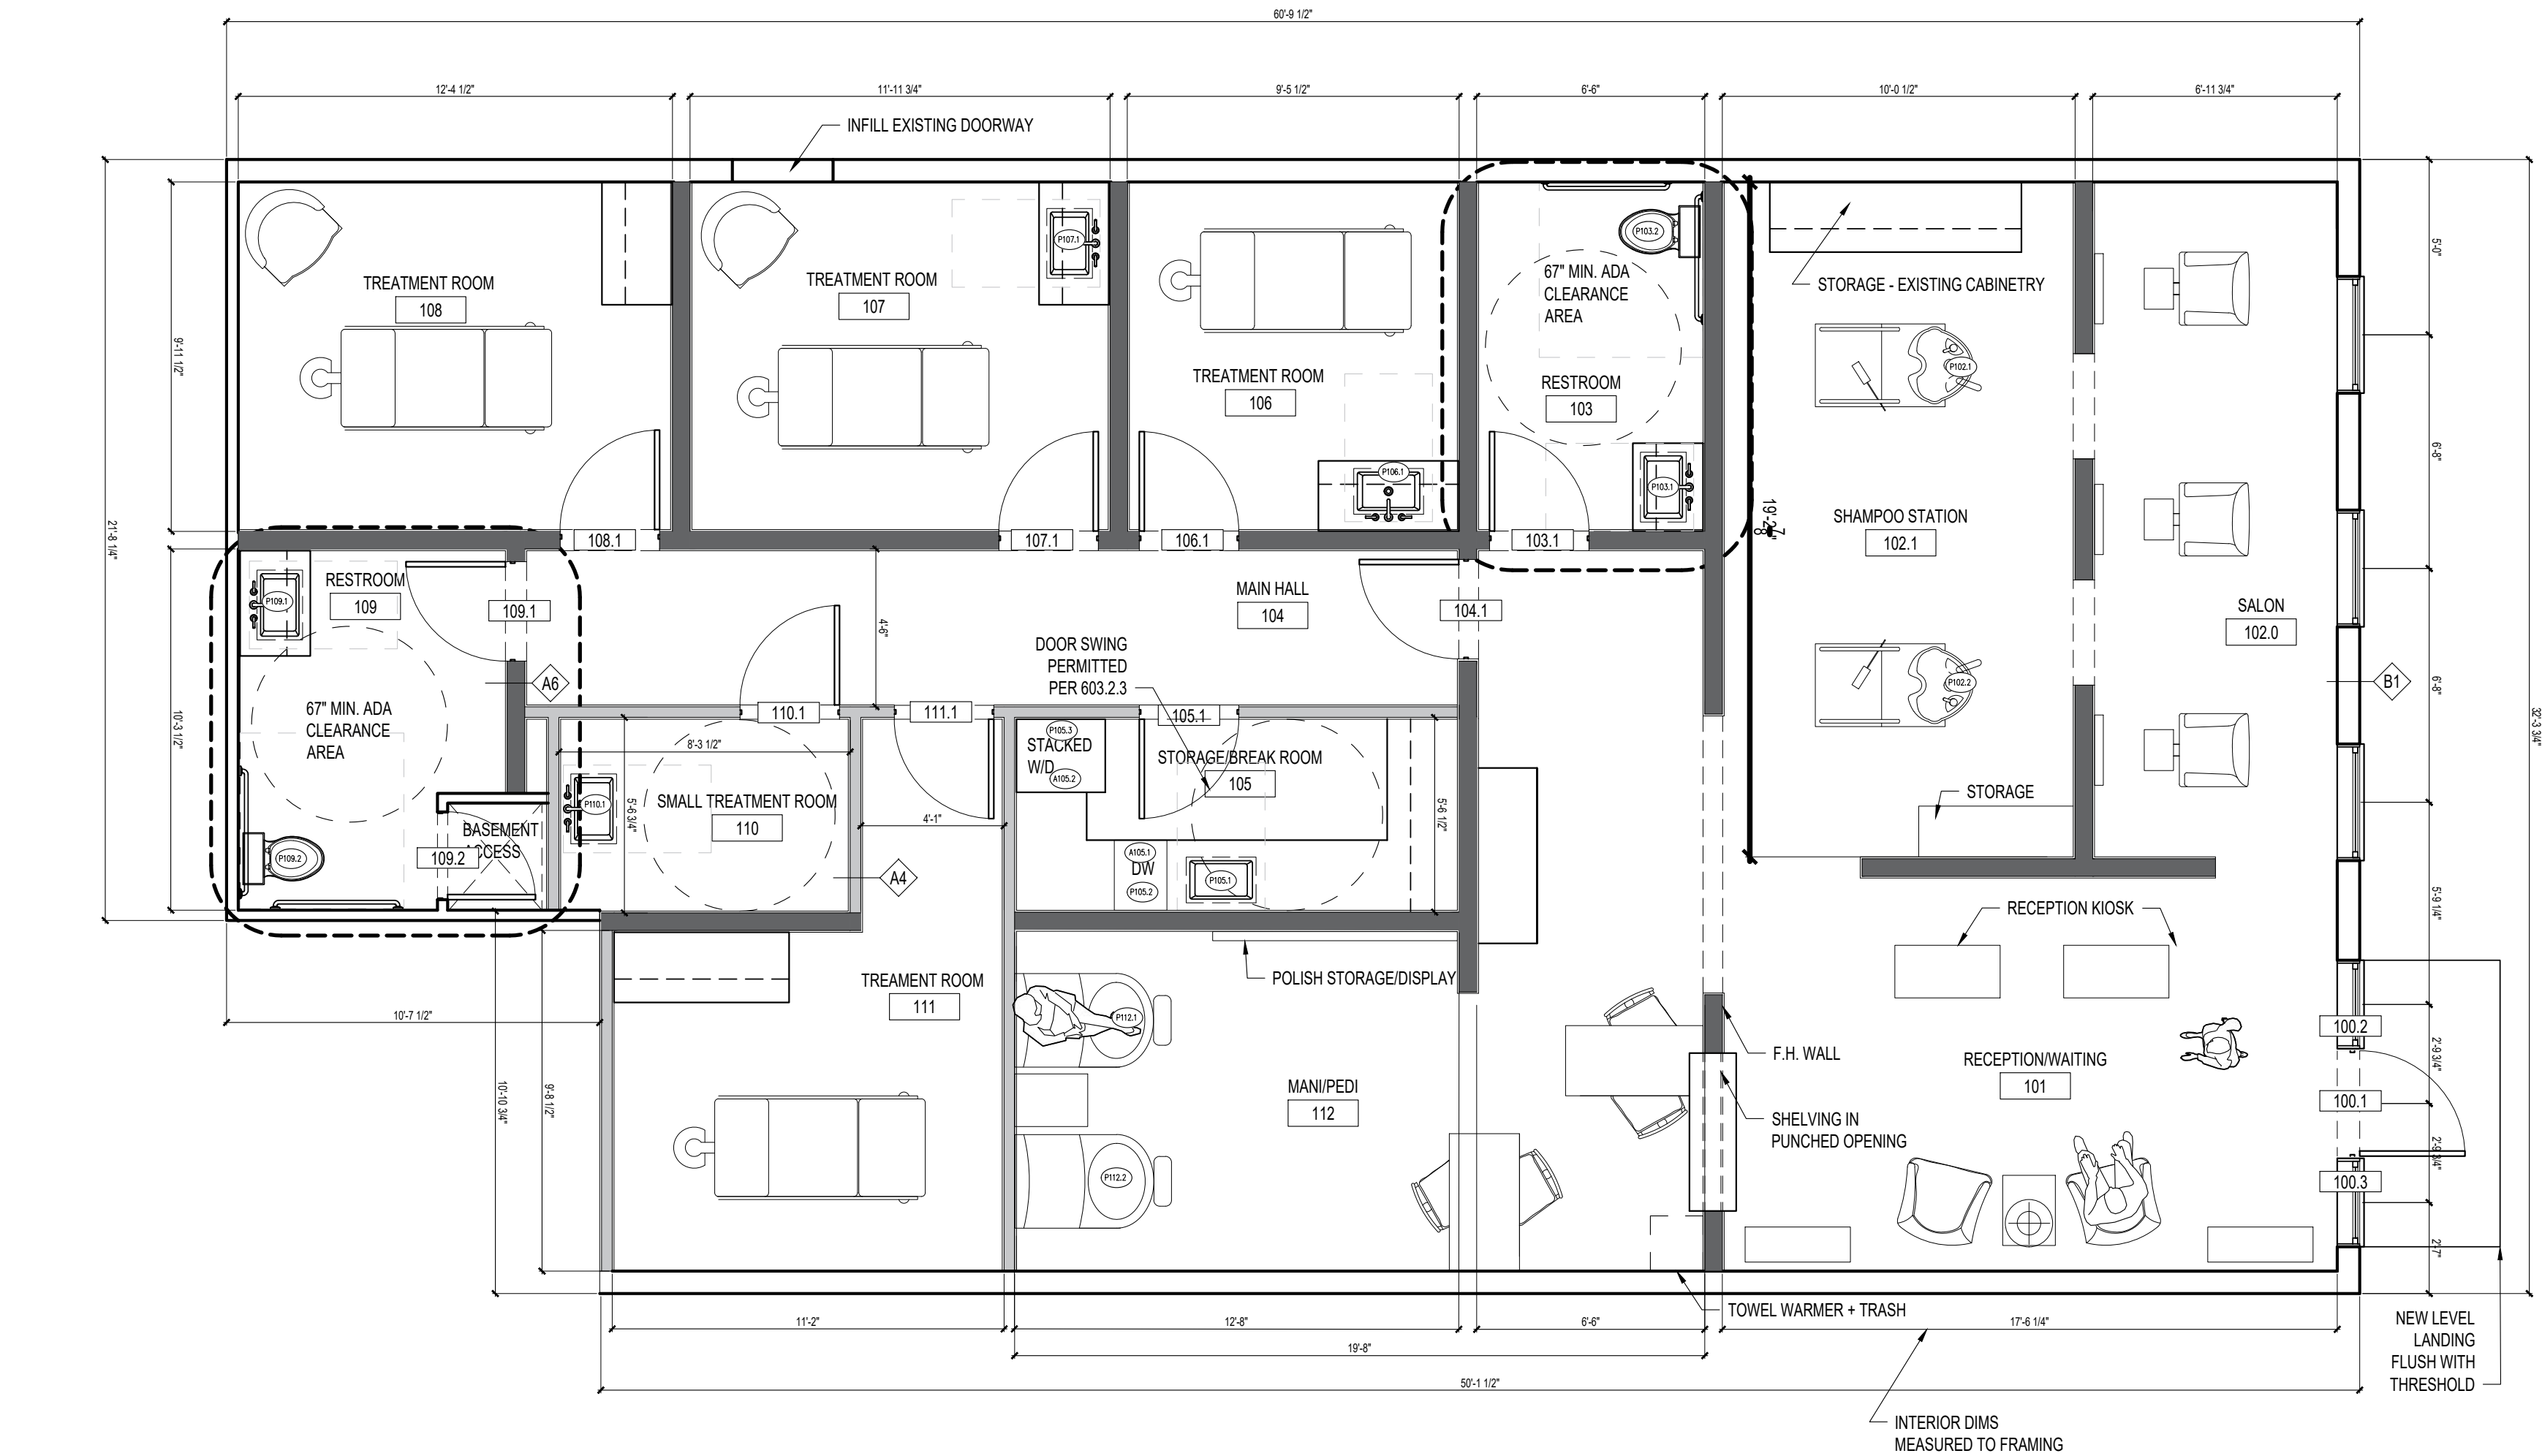
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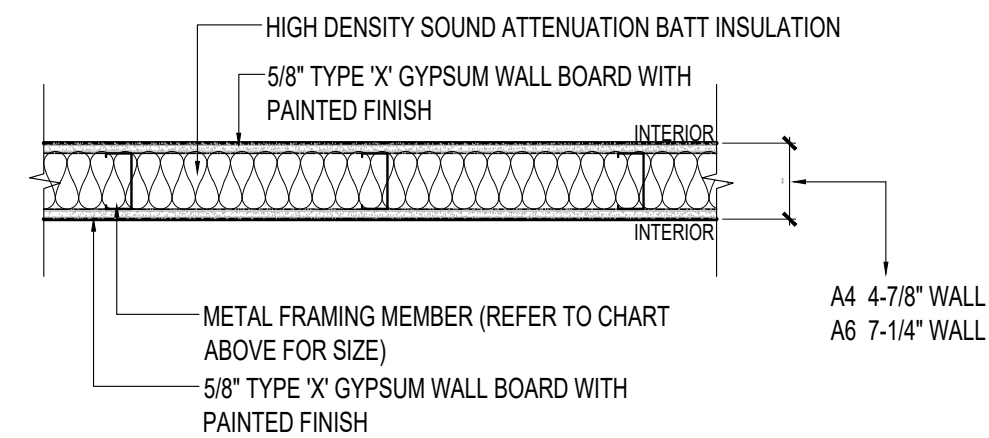
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**A** PROPOSED PLAN  
SCALE: 1/4" = 1'-0"

ROOM NO.	ROOM NAME	KEY NO.	ITEM	MFR.	MODEL	FINISH	NOTES
102	SALON	P101.1	SALON WASH BASIN FILLER	TBD	TBD	TBD	
		P101.2	SALON WASH BASIN FILLER	TBD	TBD	TBD	
103	RESTROOM	P103.1	LAVATORY SINK	TBD	TBD	TBD	ADA COMPLIANT
		P103.1	LAVATORY FAUCET	TBD	TBD	TBD	ADA COMPLIANT
		P103.2	TOILET	TBD	TBD	TBD	ADA COMPLIANT
		P105.1	LAVATORY SINK	TBD	TBD	TBD	ADA COMPLIANT
105	STORAGE/BREAK ROOM	P105.2	LAVATORY FAUCET	TBD	TBD	TBD	ADA COMPLIANT
		P105.2	DISHWASHER HOOKUP	TBD	TBD	TBD	
		P105.3	WASHER HOOKUP	TBD	TBD	TBD	ADA COMPLIANT
		A105.1	DISHWASHER	TBD	TBD	TBD	ADA COMPLIANT
		A105.2	STACKED WASHER DRYER	BY OWNER	BY OWNER	BY OWNER	
		P106.1	LAVATORY SINK	TBD	TBD	TBD	ADA COMPLIANT
106	TREATMENT ROOM	P106.2	LAVATORY FAUCET	TBD	TBD	TBD	ADA COMPLIANT
		P107.1	LAVATORY SINK	TBD	TBD	TBD	
107	TREATMENT ROOM	P107.1	LAVATORY FAUCET	TBD	TBD	TBD	ADA COMPLIANT
		P109.1	LAVATORY SINK	TBD	TBD	TBD	ADA COMPLIANT
109	RESTROOM	P109.1	LAVATORY FAUCET	TBD	TBD	TBD	ADA COMPLIANT
		P109.2	TOILET	TBD	TBD	TBD	ADA COMPLIANT
		P110.1	LAVATORY SINK	TBD	TBD	TBD	ADA COMPLIANT
110	SMALL TREATMENT ROOM	P110.1	LAVATORY FAUCET	TBD	TBD	TBD	ADA COMPLIANT
		P112.1	PEDI UNIT FILLER	TBD	TBD	TBD	
112	MANI/PEDI AREA	112.2	PEDI UNIT FILLER	TBD	TBD	TBD	

**D** PLUMBING AND APPLIANCE SCHEDULE



**Ax** WALL PARTITION-1 HOUR RATED (UL U305)  
SCALE: 1" = 1'-0"

DOOR NO.	ROOM	INT/EXT	FUNCTION	WIDTH	HEIGHT	MFR.	MODEL	STICKING	PANEL STYLE
101.1	RECEPTION/WAITING	EXT	LH SWING	36"	80"	TBD	TBD	TBD	TBD
101.2	SIDELIGHT	EXT	FIXED SIDELIGHT	24"	80"	TBD	TBD	TBD	TBD
101.3	SIDELIGHT	EXT	FIXED SIDELIGHT	24"	80"	TBD	TBD	TBD	TBD
103.1	RESTROOM	INTERIOR	LH SWING	34"	80"	TBD	TBD	TBD	TBD
104.1	MAIN HALL	INTERIOR	RH SWING	34"	80"	TBD	TBD	TBD	GLASS
105.1	STORAGE/BREAK ROOM	INTERIOR	RH SWING	34"	80"	TBD	TBD	TBD	TBD
106.1	TREATMENT ROOM	INTERIOR	LH SWING	34"	80"	TBD	TBD	TBD	TBD
107.1	TREATMENT ROOM	INTERIOR	RH SWING	34"	80"	TBD	TBD	TBD	TBD
108.1	TREATMENT ROOM	INTERIOR	RH SWING	34"	80"	TBD	TBD	TBD	TBD
109.1	RESTROOM	INTERIOR	RH SWING	34"	80"	TBD	TBD	TBD	TBD
109.2	RESTROOM	INTERIOR	RH SWING	34"	80"	TBD	TBD	TBD	TBD
110.1	SHOWER	INTERIOR	LH SWING	34"	80"	TBD	TBD	TBD	TBD
111.1	TREATMENT ROOM	INTERIOR	LH SWING	34"	80"	TBD	TBD	TBD	TBD

**E** DOOR SCHEDULE

FOR THE ARCHITECT'S USE ONLY. THESE PLANS ARE NOT TO BE USED FOR CONSTRUCTION. ANY DEVIATIONS FROM APPROVED PLANS ARE SUBJECT TO PRIOR APPROVAL. APPROVAL OF THESE PLANS DOES NOT RELIEVE THE DESIGN PROFESSIONAL, GENERAL CONTRACTOR, OR SUBCONTRACTOR OF THEIR RESPONSIBILITY FOR COMPLIANCE WITH ALL APPLICABLE CODES AND REGULATIONS. THE SET OF THESE PLANS IS TO BE AVAILABLE ON THE JOB SITE FOR USE BY INSPECTORS. SUCH PLANS ARE NOT TO BE USED FOR ANY OTHER PURPOSE. ANY INSPECTION MAY BE CANCELLED AND A REINSPECTION CHARGE LEVIED PRIOR TO THE INSPECTION. DATE: 10-22-2022. BUILDING OFFICIAL: KS.


**NORTHWORKS**

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WALL TYPE LEGEND


A4	NEW 3-5/8" METAL STUD WALL
A6	NEW 6" METAL STUD WALL
B1	EXISTING CMU WALL - TO BE PAINTED

**B** RESTROOM 109 DETAIL  
SCALE: 1/2" = 1'-0"

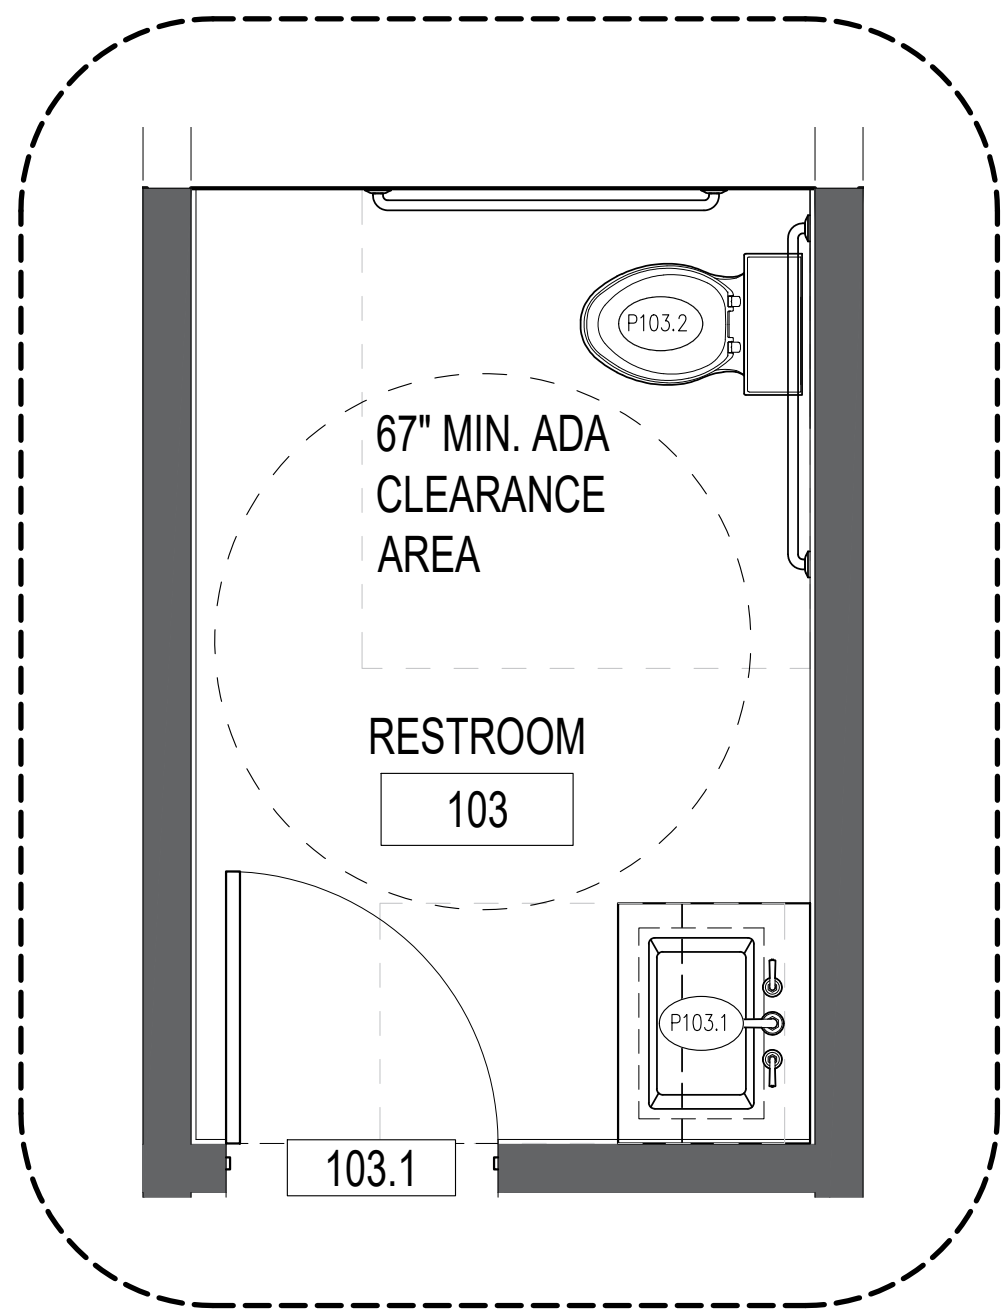

**C** RESTROOM 103 DETAIL  
SCALE: 1/2" = 1'-0"




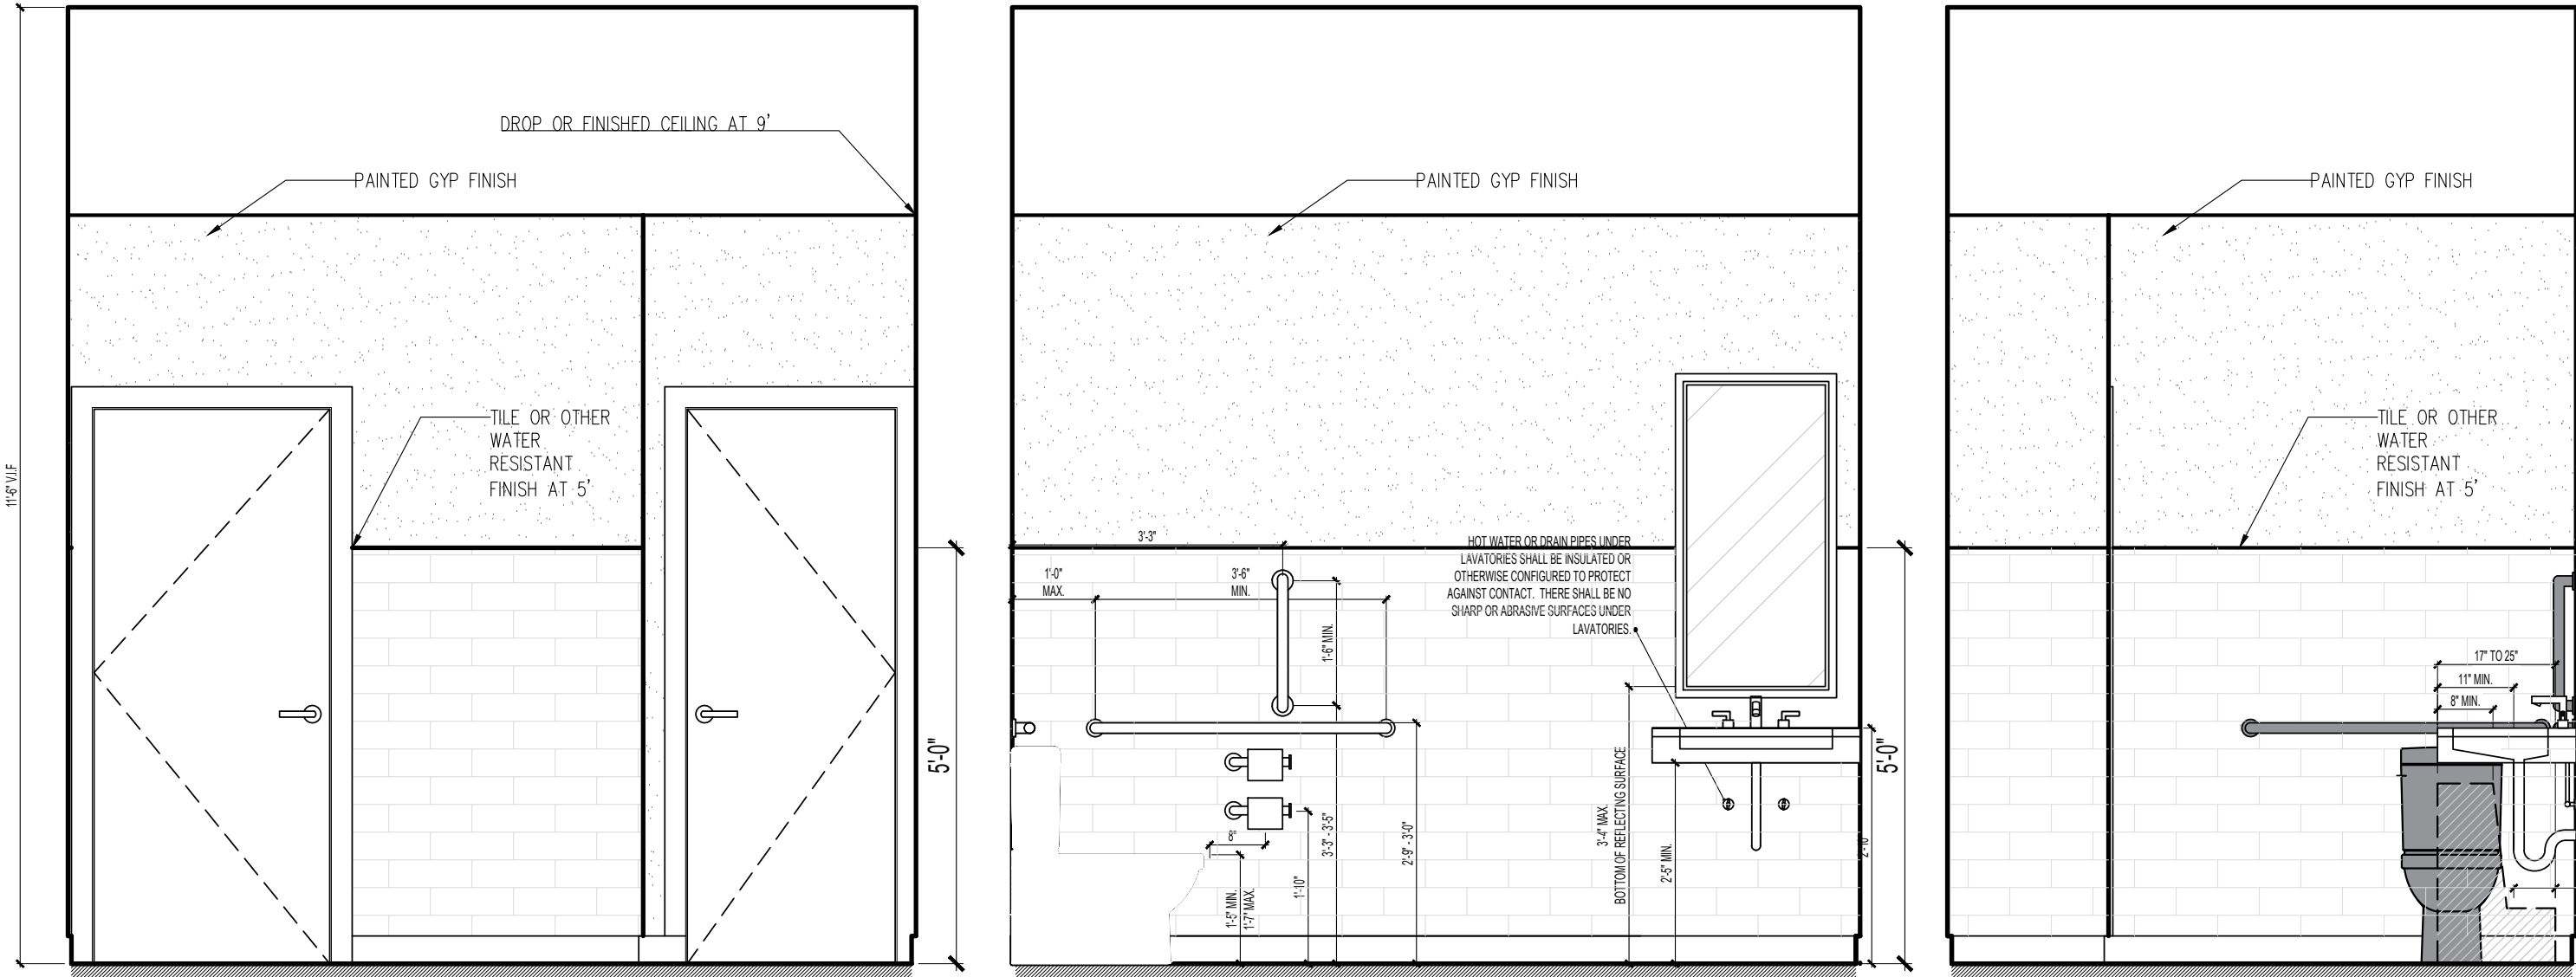

A	NORTH ELEVATION	B	EAST ELEVATION	C	WEST ELEVATION	A	NORTH ELEVATION	B	EAST ELEVATION	C	SOUTH ELEVATION
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SCALE: 1/4" = 1'-0"

SCALE: 1/4" = 1'-0"

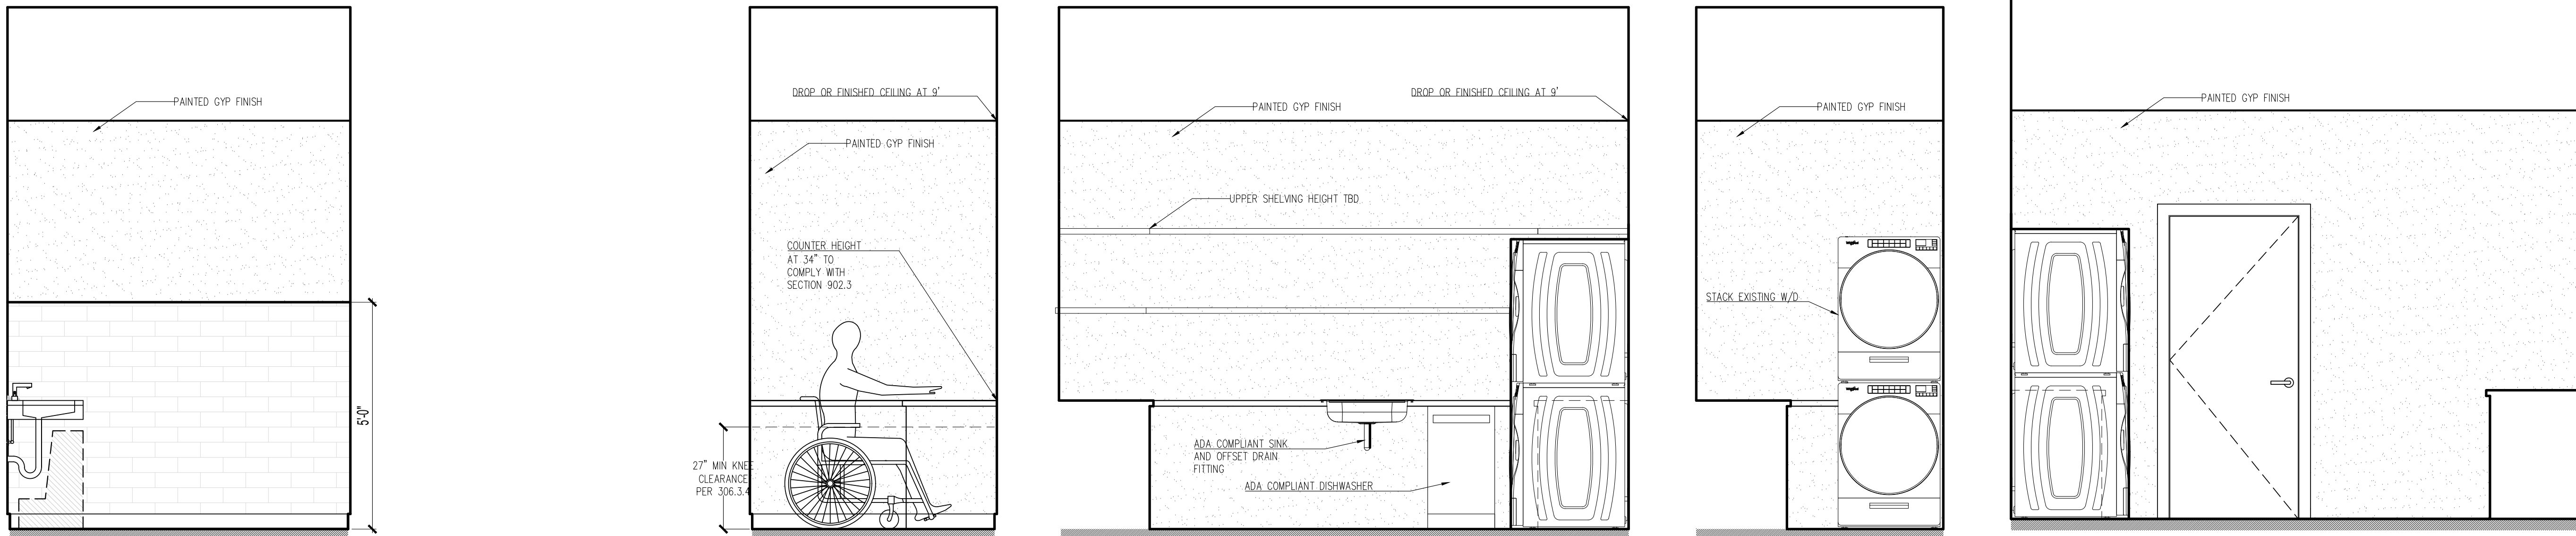

SCALE: 1/4" = 1'-0"

SCALE: 1/4" = 1'-0"

Drawing Name

INTERIOR ELEVATIONS







	1	2	3	4	5	6	7	8	9	10	11	12	13	14	15	16	17	18	19	20	21
	<b>HVAC SPECIFICATIONS:</b>																				
	1. GENERAL:																				
	1.A. ALL APPLICABLE CODES, LAWS AND REGULATIONS GOVERNING OR RELATING TO ANY PORTION OF THIS WORK ARE HEREBY INCORPORATED INTO AND MADE A PART OF THESE SPECIFICATIONS, AND THEIR PROVISIONS SHALL BE CARRIED OUT BY THE CONTRACTOR WHO SHALL INFORM THE OWNER, PRIOR TO SUBMITTING A PROPOSAL, OF ANY WORK OR MATERIAL WHICH VIOLATED ANY OF THE ABOVE LAWS AND REGULATION. ANY WORK DONE BY THE CONTRACTOR CAUSING SUCH A VIOLATION SHALL BE CORRECTED BY THE CONTRACTOR.					1.X.2.	CUSTODY, AND CONTROL OF THE OWNER. ENGAGE THE SERVICES OF VARIOUS MANUFACTURERS SUPPLYING THE EQUIPMENT FOR THE PROPER STARTUP AND OPERATION OF ALL SYSTEMS INSTALLED. INSTRUCT THE OWNERS PERSONNEL IN THE PROPER OPERATION AND SERVICING OF THE SYSTEM. THE CONTRACTOR SHALL FURNISH A WRITTEN GUARANTEE TO REPLACE OR REPAIR PROMPTLY AND ASSUME RESPONSIBILITY FOR ALL EXPENSES INCURRED FOR ANY WORKMANSHIP AND EQUIPMENT IN WHICH DEFECTS DEVELOP WITHIN THE GUARANTEE PERIOD. THIS WORK SHALL BE DONE AS DIRECTED BY THE OWNER. THIS GUARANTEE SHALL INCLUDE RESPONSIBILITY FOR ALL EXPENSES INCURRED IN REPAIRING AND REPLACING WORK OF OTHER TRADES AFFECTED BY DEFECTS, REPAIRS OR REPLACEMENTS IN EQUIPMENT SUPPLIED BY THIS CONTRACTOR.														
	1.B. INVESTIGATE EACH SPACE THROUGH WHICH EQUIPMENT MUST BE MOVED OR INSTALLED. WHERE NECESSARY, EQUIPMENT SHALL BE SHIPPED FROM MANUFACTURER IN SECTIONS OF SIZE SUITABLE FOR MOVING THROUGH AVAILABLE RESTRICTIVE SPACES. ASCERTAIN FROM BUILDING OWNER AT WHAT TIMES OF DAY EQUIPMENT MAY BE MOVED THROUGH ALL AREAS.					1.X.3.	THIS CONTRACTOR IS RESPONSIBLE FOR THE MAINTENANCE AND OPERATION OF ALL SYSTEMS UNTIL THE FINAL ACCEPTANCE OF THE WORK.														
	1.C. DUCTWORK AND PIPING IS SHOWN DIAGRAMMATICALLY AND DOES NOT SHOW ALL OFFSETS, DROPS AND RISES OF RUNS. THE CONTRACTOR SHALL ALLOW IN THEIR PRICE FOR ROUTING OF DUCTWORK AND PIPING TO AVOID OBSTRUCTIONS. EXACT LOCATIONS ARE SUBJECT TO APPROVAL OF ENGINEER/OWNER. COORDINATION WITH THE EXISTING SERVICES, INCLUDING THOSE OF OTHER TRADES IS REQUIRED.					1.X.4.	ALL AIR CONDITIONING UNIT COMPRESSORS AND REFRIGERATION COMPONENTS SHALL HAVE A 5-YEAR WARRANTY.														
	1.D. SUPPORT ALL DUCTWORK AND PIPING FROM BUILDING STRUCTURE AND/OR FRAMING IN AN APPROVED MANNER. WHERE OVERHEAD CONSTRUCTION DOES NOT PERMIT FASTENING OR SUPPORTS FOR EQUIPMENT, FURNISH ADDITIONAL FRAMING. INSERTS SHALL BE STEEL, SLOTTED TYPE AND FACTORY PAINTED. SINGLE ROD SHALL BE SIMILAR TO GRINNELL FIG. 281. MULTI-ROD SHALL BE SIMILAR TO FEE & MASON SERIES 9000 WITH END CAPS AND CLOSURE STRIPS. MAXIMUM LOADING INCLUDING PIPES, DUCTWORK CONTENTS AND COVERING SHALL NOT EXCEED 75% OF RATED INSERT CAPABILITY. WHEN SUPPORTING FROM BUILDING USE BEAM CLAMPS IN APPROVED MANNER.					1.Y.	SPECIFICATIONS ARE OF SIMPLIFIED FORM AND INCLUDE INCOMPLETE SENTENCES. WORDS OR PHRASES SUCH AS "THE CONTRACTOR SHALL," "SHALL BE," "FURNISH," "PROVIDE," "A," "THE," AND "ALL" HAVE BEEN OMITTED FOR BREVITY.														
	1.E. INSTALL WORK SO AS TO BE READILY ACCESSIBLE FOR OPERATION, MAINTENANCE AND REPAIR. MINOR DEVIATIONS FROM DRAWINGS MAY BE MADE TO ACCOMPLISH THIS, BUT CHANGES WHICH INVOLVE EXTRA COST SHALL NOT BE MADE WITHOUT APPROVAL.					1.Z.1.	"PROVIDE": TO SUPPLY, INSTALL AND CONNECT UP COMPLETE AND READY FOR SAFE AND REGULAR OPERATION THE PARTICULAR WORK REFERRED TO UNLESS SPECIFICALLY OTHERWISE NOTED.														
	1.F. THE CONTRACTOR SHALL SUBMIT TO THE ENGINEER FOR APPROVAL A PLAN INDICATING THE SIZE (MINIMUM 18 INCH X 18 INCH) AND LOCATION OF ALL ACCESS DOORS REQUIRED FOR OPERATION AND MAINTENANCE OF ALL CONCEALED EQUIPMENT, DEVICES, VALVES, DAMPERS AND CONTROLS. CONTRACTOR SHALL ARRANGE FOR FURNISHING AND INSTALLATION OF ALL ACCESS DOORS IN FINISHED CONSTRUCTION AND INCLUDE COSTS IN THE BID.					1.Z.2.	"INSTALL": TO ERECT, MOUNT AND CONNECT COMPLETE WITH RELATED ACCESSORIES.														
	1.G. REMOVAL AND RELOCATION OF CERTAIN EXISTING WORK WILL BE NECESSARY FOR THE PERFORMANCE OF THE GENERAL WORK. ALL EXISTING CONDITIONS CANNOT BE COMPLETELY DETAILED ON THE DRAWINGS. THE CONTRACTOR SHALL SURVEY THE SITE AND INCLUDE ALL CHANGES IN MAKING UP THE WORK PROPOSAL.					1.Z.3.	"FURNISH" OR "SUPPLY": TO PURCHASE, PROCURE, ACQUIRE AND DELIVER COMPLETE WITH RELATED ACCESSORIES.														
	1.H. PLAN INSTALLATION OF NEW WORK AND CONNECTIONS TO EXISTING WORK TO ENSURE MINIMUM INTERFERENCE WITH REGULAR OPERATION OF EXISTING FACILITIES. ALL SYSTEM SHUTDOWNS AFFECTING OTHER AREAS SHALL BE COORDINATED WITH BUILDING OWNER. INSTALL ISOLATION VALVES AT POINT OF CONNECTION TO THE EXISTING PIPING. PROVIDE TEMPORARY DUCT CAPS AND/OR CONNECTIONS TO MINIMIZE SHUTDOWN TIME.					1.Z.4.	"WORK": LABOR, MATERIALS, EQUIPMENT, APPARATUS, CONTROLS, ACCESSORIES AND OTHER ITEMS REQUIRED FOR PROPER AND COMPLETE INSTALLATION.														
	1.I. CONNECT NEW WORK TO EXISTING WORK IN NEAT AND APPROVED MANNER. RESTORE EXISTING WORK DISTURBED WHILE INSTALLING NEW WORK TO ACCEPTABLE CONDITION AS DETERMINED BY ARCHITECT.					1.Z.5.	"CONCEALED": EMBEDDED IN MASONRY OR OTHER CONSTRUCTION, INSTALLED IN FURRED SPACES, WITHIN DOUBLE PARTITIONS OR HUNG CEILINGS, IN TRENCHES, IN CRAWL SPACES, OR IN ENCLOSURES.														
	1.J. DISCONNECT, REMOVE AND/OR RELOCATE EXISTING MATERIAL, EQUIPMENT AND OTHER WORK AS NOTED OR REQUIRED FOR PROPER INSTALLATION OF NEW SYSTEM.					1.Z.6.	"EXPOSED": NOT INSTALLED UNDERGROUND OR "CONCEALED" AS DEFINED ABOVE.														
	1.K. THE CONTRACTOR SHALL KEEP ALL EQUIPMENT AND MATERIALS, AND ALL PARTS OF THE BUILDING, EXTERIOR SPACES AND ADJACENT STREETS, SIDEWALKS AND PAVEMENTS, FREE FROM MATERIAL AND DEBRIS RESULTING FROM THE EXECUTION OF THIS WORK. EXCESS MATERIALS WILL NOT BE PERMITTED TO ACCUMULATE EITHER ON THE INTERIOR OR THE EXTERIOR.					1.Z.7.	"SIMILAR" OR "EQUAL": EQUAL IN MATERIALS, WEIGHT, SIZE, DESIGN AND EFFICIENCY OF SPECIFIED PRODUCT.														
	1.L. SEAL OPENINGS AROUND DUCTS AND PIPING THROUGH PARTITIONS, WALLS AND FLOORS (NOT IN SHAFTS) WITH MINERAL WOOL OR OTHER NONCOMBUSTIBLE MATERIAL.					2.	SCOPE OF WORK:														
	1.M. PROVIDE ALL NECESSARY FLASHING AND COUNTERFLASHING TO MAINTAIN THE WATERPROOFING INTEGRITY OF THIS BUILDING AS REQUIRED BY THE INSTALLATION OR REMOVAL OF PIPES, DUCTS, LOUVERS, CONDUIT, AND EQUIPMENT. PROVIDE EQUIPMENT CURBS AND DUNNAGE STEEL AS REQUIRED.					2.A.	THE WORK UNDER CONTRACT INCLUDES ALL LABOR, MATERIALS AND APPLIANCES NECESSARY FOR THE FURNISHING, INSTALLING AND TESTING, COMPLETE AND READY FOR SAFE OPERATION OF THE SYSTEMS. WORK SHALL BE INSTALLED IN A NEAT, WORKMANLIKE MANNER.														
	1.N. ALL PRESENT MATERIAL, EQUIPMENT AND CONSTRUCTION DEBRIS TO BE REMOVED UNDER THIS CONTRACT SHALL BECOME THE PROPERTY OF THE CONTRACTOR WITH THE EXCEPTION OF SPECIFIC EQUIPMENT AND APPARATUS REQUESTED BY THE BUILDING REPRESENTATIVE, ENGINEER OR AS NOTED TO BE RELOCATED ON THE DRAWINGS SHALL BE PROPERLY DISPOSED OF BY THIS CONTRACTOR.					2.B.	THE CONTRACTOR SHALL GIVE NECESSARY NOTICE, FILE DRAWINGS AND SPECIFICATIONS WITH THE DEPARTMENT HAVING JURISDICTION, OBTAIN PERMITS OR LICENSES NECESSARY TO CARRY OUT THIS WORK AND PAY ALL FEES THEREFORE. THE CONTRACTOR SHALL ARRANGE FOR INSPECTION AND TESTS OF ANY OR ALL PARTS OF THE WORK IF SO REQUIRED BY AUTHORITIES AND PAY ALL CHARGES FOR SAME. THE CONTRACTOR SHALL PAY ALL COSTS FOR, AND FURNISH TO THE OWNER BEFORE FINAL BILLING, ALL CERTIFICATES NECESSARY AS EVIDENCE THAT THE WORK INSTALLED CONFORMS WITH ALL REGULATIONS WHERE THEY APPLY TO THIS WORK.														
	1.O. MATERIALS AND WORKMANSHIP, UNLESS OTHERWISE NOTED, SHALL BE IN ACCORDANCE WITH BUILDING STANDARDS.					2.C.	PRIOR TO THE INSTALLATION OF ANY WORK AND PROCUREMENT OF EQUIPMENT PROVIDE COMPLETE SET OF COORDINATED SHOP DRAWINGS OF ALL NEW AND EXISTING EQUIPMENT, DUCTWORK, PIPING AND CONTROL SYSTEMS INDICATING CAPACITY DIMENSIONS AND SEQUENCE OF OPERATION FOR WRITTEN APPROVAL BY THE ENGINEER.														
	1.P. THE WORK IN THE BUILDING SHALL BE DONE WHEN AND AS DIRECTED, AND IN A MANNER SATISFACTORY TO THE OWNER. THE WORK SHALL BE PERFORMED SO AS TO CAUSE THE LEAST POSSIBLE INCONVENIENCE AND DISTURBANCE TO THE PRESENT OCCUPANTS.					2.D.	WITHIN 15 DAYS AFTER AWARD OF CONTRACT, SUBMIT FOR REVIEW, A LIST OF ALL MATERIAL AND EQUIPMENT MANUFACTURER'S PRODUCTS THAT ARE PROPOSED, AS WELL AS NAMES OF ALL SUBCONTRACTORS WHOM THIS TRADE PROPOSES TO UTILIZE ON THIS PROJECT.														
	1.Q. THE CONTRACTOR'S PROPOSAL FOR ALL WORK SHALL BE PREDICATED ON THE PERFORMANCE OF THE WORK DURING REGULAR WORKING HOURS. WHEN SO DIRECTED, HOWEVER, THE CONTRACTOR SHALL INSTALL WORK IN OVERTIME AND THE ADDITIONAL COST TO BE CHARGED THEREFORE SHALL BE ONLY THE "PREMIUM" PORTION OF THE WAGES PAID.					3.	SHOP DRAWINGS:														
	1.R. UNLESS OTHERWISE SPECIFICALLY SPECIFIED, INCLUDE ALL CUTTING AND PATCHING OF EXISTING FLOORS, WALLS, PARTITIONS AND OTHER MATERIALS IN THE EXISTING BUILDING. THE CONTRACTOR SHALL RESTORE THESE AREAS TO ORIGINAL CONDITION.					3.A.	INDICATE ON EACH SUBMISSION: PROJECT NAME AND LOCATION, ENGINEER, ITEM IDENTIFICATION AND APPROVAL STAMP OF PRIME CONTRACTOR, SUBCONTRACTOR NAMES AND PHONE NUMBERS, REFERENCE TO THE APPLICABLE DESIGN DRAWING OR SPECIFICATION ARTICLE, DATE AND SCALE.														
	1.S. REMOVABLE ACCESS TILE AND/OR ACCESS DOOR ARE REQUIRED IN HUNG CEILINGS, SHAFTS AND WALLS FOR ALL VOLUME AND FIRE DAMPERS, AUTOMATIC DAMPERS AND ALL OTHER MECHANICAL EQUIPMENT AND DEVICES. HVAC CONTRACTOR TO FURNISH ACCESS LOCATION REQUIREMENTS TO GENERAL CONTRACTOR. ACCESS TILE IDENTIFICATION: PROVIDE BUTTONS, TABS, AND MARKERS TO IDENTIFY LOCATION OF CONCEALED VALVES, DAMPERS AND EQUIPMENT.					3.B.	THE WORK DESCRIBED IN ALL SHOP DRAWING SUBMISSION SHALL BE CAREFULLY CHECKED FOR ALL CLEARANCES (INCLUDING THOSE REQUIRED FOR MAINTENANCE AND SERVICING), FIELD CONDITIONS, MAINTENANCE OF ARCHITECTURAL CONDITIONS AND PROPER COORDINATION WITH ALL TRADES ON THE JOB.														
	1.T. ALL MATERIAL AND EQUIPMENT TO BE NEW UNLESS OTHERWISE NOTED AND SHALL BE IN ACCORDANCE WITH BUILDING STANDARDS.					3.C.	EACH SUBMITTED SHOP DRAWING IS TO INCLUDE A CERTIFICATION THAT ALL RELATED JOB CONDITIONS HAVE BEEN CHECKED AND VERIFIED AND THAT THERE ARE NO CONFLICTS.														
	1.U. SUBMISSION OF A PROPOSAL SHALL BE CONSTRUED AS EVIDENCE THAT A CAREFUL EXAMINATION OF THE PORTIONS OF THE EXISTING BUILDING, EQUIPMENT, ETC., WHICH AFFECT THIS WORK, AND THE ACCESS TO SUCH SPACES, HAS BEEN MADE AND THAT THE CONTRACTOR IS FAMILIAR WITH EXISTING CONDITIONS AND DIFFICULTIES THAT WILL AFFECT THE EXECUTION OF THE WORK. LATER CLAIMS SHALL NOT BE MADE FOR LABOR, EQUIPMENT OR MATERIALS REQUIRED BECAUSE OF DIFFICULTIES ENCOUNTERED WHICH COULD HAVE BEEN FORESEEN DURING SUCH AN EXAMINATION. THE ON-SITE INSPECTION SHALL VERIFY EXISTING DUCTWORK, PIPING (SIZES, CLEARANCES, ETC.) AND CONDITIONS.					3.D.	ALL SHOP DRAWINGS ARE TO BE SUBMITTED TO ALLOW AMPLE TIME FOR CHECKING IN ADVANCE OF FIELD REQUIREMENTS. ALL SUBMITTALS TO BE COMPLETE AND CONTAIN ALL REQUIRED AND DETAILED INFORMATION. SHOP DRAWINGS WITH MULTIPLE PARTS SHALL BE SUBMITTED AS A PACKAGE.														
	1.V. INSURANCE: IN ACCORDANCE WITH BUILDING REQUIREMENTS AND SHALL INCLUDE A HOLD HARMLESS CLAUSE FOR OWNER AND ENGINEER.					3.E.	IF SUBMITTALS DIFFER FROM THE CONTRACT DOCUMENT REQUIREMENTS, MAKE SPECIFIC MENTION OF SUCH DIFFERENCES IN A LETTER OF TRANSMITTAL, WITH REQUEST FOR SUBSTITUTION, TOGETHER WITH REASONS FOR SAME.														
	1.W. THE FINAL ACCEPTANCE WILL BE MADE AFTER THE CONTRACTOR HAS ADJUSTED THEIR EQUIPMENT, BALANCED THE VARIOUS SYSTEMS, DEMONSTRATED THAT IT FULFILLS THE REQUIREMENTS OF THE DRAWINGS AND SPECIFICATIONS AND HAS FURNISHED ALL THE REQUIRED CERTIFICATES OF INSPECTION AND APPROVAL.					3.F.	SUBMISSIONS:														
	1.X. GUARANTEE:					3.F.1.	PROVIDE ALL COORDINATION DRAWINGS, DUCTWORK AND PIPING SHOP DRAWINGS IN AUTOCAD FORMAT, VERSION COMPATIBLE WITH OWNER. ALL CATALOG CUTS AND SUBMITTALS TO BE PROVIDED IN ELECTRONIC "PDF" FORMAT THE ARCHITECT WILL FORWARD ALL SUBMISSIONS TO THE ENGINEER.														
	1.X.1. ALL MATERIALS AND WORKMANSHIP SHALL BE GUARANTEED FOR A PERIOD OF ONE YEAR FROM DATE OF FINAL ACCEPTANCE OF THIS WORK. FINAL ACCEPTANCE SHALL BE DEFINED AS THE TIME AT WHICH THE MECHANICAL WORK IS TAKEN OVER AND ACCEPTED BY THE OWNER, AND IS UNDER CARE,					3.G.	SUBMIT SHOP DRAWINGS FOR THE FOLLOWING:														
						3.G.1.	DUCTWORK LAYOUT AND SHEET METAL DESIGNS.														
						3.G.1.1.	SHEETMETAL SHOP STANDARDS SHALL BE COMPILED DIRECTLY FROM THE "SMACNA DUCT CONSTRUCTION STANDARDS- METAL AND FLEXIBLE" MANUAL. MODIFICATIONS FOR A SPECIFIC PROJECT, IF ANY, SHALL BE INDICATED DIRECTLY ON THE SMACNA TEMPLATES. MODIFIED SHOP STANDARDS NOT TAKEN DIRECTLY FROM THE SMACNA TEMPLATES WILL NOT BE ACCEPTED. ANY DEVIATIONS FROM SMACNA SHALL BE NOTED.														
						3.G.2.	REGISTERS, GRILLES AND DIFFUSERS.														
						3.G.3.	DUCTWORK, PIPING AND EQUIPMENT LABELS.														
						3.G.4.	DUCTWORK PIPNG AND EQUIPMENT INSULATION.														
						3.G.5.	AIR BALANCE REPORT.														
						3.G.6.	HEAT PUMP UNITS.														
						3.G.7.	EXHAUST FANS.														
						3.G.8.	PUMPS.														
						3.G.9.	VALVES														
						3.G.10.	VIBRATION AND SEISMIC ISOLATION.														
						3.G.11.	AUTOMATIC CONTROL SYSTEMS AND DEVICES.														
						3.G.12.	SEQUENCE OF OPERATIONS														
						3.H.	COORDINATION DRAWINGS: PLANS, DRAWN TO SCALE INDICATING COORDINATION BETWEEN THE TRADES USING INPUT FROM INSTALLERS OF THE ITEMS INVOLVED:														
						3.H.1.	COORDINATION WITH SUSPENDED CEILING COMPONENTS, STRUCTURAL MEMBERS TO WHICH DUCT WILL BE ATTACHED, SIZE AND LOCATION OF INITIAL ACCESS MODULES FOR ACOUSTICAL TILE, PENETRATIONS OF SMOKE BARRIERS AND FIRE-RATED CONSTRUCTION, LIGHTING FIXTURES, AIR OUTLETS AND INLETS, SPEAKERS,SPRINKLERS,ACCESS PANELS,PERIMETER MOLDINGS SHALL BE PERFORMED.														
						4.	AS-BUILTS AND EQUIPMENT OPERATING INSTRUCTIONS:														
						4.A.	PROVIDE ALL COORDINATION DRAWINGS, DUCTWORK AND PIPING SHOP DRAWINGS IN AUTOCAD FORMAT,VERSION COMPATIBLE WITH OWNER. ALL CATALOG CUTS AND SUBMITTALS TO BE PROVIDED IN ELECTRONIC "PDF" FORMAT THE ARCHITECT WILL FORWARD ALL SUBMISSIONS TO THE ENGINEER.														
						4.B.	ON COMPLETION AND ACCEPTANCE OF WORK, THIS CONTRACTOR SHALL FURNISH WRITTEN INSTRUCTIONS AND EQUIPMENT MANUALS IN ELECTRONIC FORMAT. CONTRACTOR SHALL DEMONSTRATE TO THE OWNER THE PROPER OPERATION AND MAINTENANCE OF ALL EQUIPMENT AND APPARATUS FURNISHED UNDER THIS CONTRACT.														
						4.C.	THESE INSTRUCTIONS SHALL BE TYPED ON 8-1/2 INCH X 11 IN FORMAT. THE CONTRACTOR SHALL GIVE ONE COPY OF THE INSTRUCTIONS TO THE OWNER AND ONE COPY TO THE ENGINEER.														
						4.D.	THE INSTRUCTIONS SHALL BE ORGANIZED IN SECTIONS, WITH ONE SECTION PER SYSTEM. THE COVER OF THE INSTRUCTION BOOKLET SHALL BEAR THE NAME, ADDRESS AND PHONE NUMBER OF THE PROJECT, ARCHITECT, ENGINEER, MECHANICAL CONTRACTOR AND SUBCONTRACTORS.														
						4.E.	FINAL "AS-BUILT" DRAWINGS INDICATING AS INSTALLED CONDITIONS SHALL BE PROVIDED TO THE ENGINEER AFTER COMPLETION OF THE INSTALLATION.														
						5.	SUBSTITUTIONS:														
						5.A.	NO SUBSTITUTE MATERIAL OR MANUFACTURER OF EQUIPMENT SHALL BE PERMITTED WITHOUT A FORMAL WRITTEN SUBMITTAL TO THE ENGINEER WHICH INCLUDES ALL DIMENSIONAL, PERFORMANCE AND MATERIAL SPECIFICATIONS. ANY CHANGES IN LAYOUT, ELECTRICAL CHARACTERISTICS, STRUCTURAL REQUIREMENTS OR DESIGN DUE TO THE USE OF A SUBSTITUTION SHALL BE SUBMITTED TO THE ENGINEER AS PART OF THIS PROPOSAL. THE CONTRACTOR TAKES FULL RESPONSIBILITY FOR THE SUBSTITUTION AND ALL CHANGES RESULTING FROM THE SUBSTITUTION. ALL ITEMS SHALL BE SUBMITTED FOR REVIEW IN CONJUNCTION WITH THE SUBMITTAL OF THE SUBSTITUTION. ANY SUBSTITUTION MUST BE SUBMITTED WITH AN EXPLANATION WHY A SUBSTITUTION IS BEING UTILIZED. IF THE SUBSTITUTED ITEM DEVIATES FROM THE SPECIFIED ITEM, THOSE DEVIATIONS ARE TO BE IDENTIFIED ON A LINE BY LINE BASIS. IF THE SUBSTITUTE IS BEING UTILIZED FOR FINANCIAL REASONS, THE ASSOCIATED CREDIT MUST BE SIMULTANEOUSLY SUBMITTED.														
						5.B.	ALL SUBSTITUTED EQUIPMENT SHALL CONFORM TO SPACE REQUIREMENTS AND PERFORMANCE REQUIREMENTS SHOWN ON CONTRACT DOCUMENTS. CONTRACTOR SHALL REPLACE ANY EQUIPMENT THAT DOES NOT MEET THESE REQUIREMENTS AT HIS OWN EXPENSE. ANY MODIFICATIONS TO ASSOCIATED SYSTEMS OR ADDITIONAL COSTS ATTRIBUTED TO THIS SUBSTITUTION SHALL BE AT THIS CONTRACTOR'S EXPENSE.														
						5.C.	CONTRACTOR SHALL SUBMIT BID BASED ON SPECIFIED ITEMS AND SHALL SUPPLY AS AN ALTERNATE PRICE ANY SUBSTITUTIONS.														
						6.	ACCESS DOORS IN GENERAL CONSTRUCTION														
						6.A.	THIS CONTRACTOR SHALL SUBMIT TO THE ARCHITECT FOR APPROVAL A PLAN INDICATING THE SIZE (MINIMUM 18 INCH X 18 INCH) AND LOCATION OF ALL ACCESS DOORS REQUIRED FOR OPERATION AND MAINTENANCE OF ALL CONCEALED EQUIPMENT, DEVICES, VALVES, DAMPERS AND CONTROLS. CONTRACTOR SHALL ARRANGE FOR FURNISHING AND INSTALLATION OF ALL ACCESS DOORS IN FINISHED CONSTRUCTION AND INCLUDE COSTS IN THE BID.														
						7.	SHEET METAL WORK:														
						7.A.	DUCT CONSTRUCTION, INCLUDING SHEET METAL THICKNESSES, SEAM AND JOINT CONSTRUCTION, REINFORCEMENTS, AND HANGERS AND SUPPORTS, SHALL COMPLY WITH SMACNA'S "HVAC DUCT CONSTRUCTION STANDARDS - METAL AND FLEXIBLE, LATEST EDITION" AND PERFORMANCE REQUIREMENTS AND DESIGN CRITERIA INDICATED.														
						7.B.	EXCEPT AS OTHERWISE SHOWN OR NOTED, ALL DUCTWORK AND OTHER SHEET METAL WORK SHALL BE GALVANIZED SHEET STEEL														
						7.C.	DESCRIPTION OF DUCTWORK PRESSURE CLASS AND EQUIPMENT:														
						7.C.1.	2 INCH DUCT CLASS AND LESS: ALL LOW PRESSURE DUCTWORK, SEAL CLASS "B", LEAKAGE CLASS 24 (RECTANGULAR) OR CLASS 12 (ROUND).														
						7.D.	GENERAL FABRICATION REQUIREMENTS: COMPLY WITH SMACNA'S "HVAC DUCT CONSTRUCTION STANDARDS - METAL AND FLEXIBLE", LATEST EDITION, BASED ON INDICATED STATIC-PRESSURE CLASS UNLESS OTHERWISE INDICATED.														
						7.D.1.	THE FOLLOWING FITTING CONNECTIONS AND DUCT CONSTRUCTION GAUGES ARE NOT ACCEPTABLE														
						7.D.1.A.	DRIVE SLIP [T-1, T-2] FITTING CONNECTIONS														
						7.D.1.B.	26 GAUGE DUCTWORK														
						7.D.2.	TRANSVERSE JOINTS: SELECT JOINT TYPES AND FABRICATE ACCORDING TO SMACNA'S "HVAC DUCT CONSTRUCTION STANDARDS - METAL AND FLEXIBLE, "TRANSVERSE (GIRTH) JOINTS"; FOR STATIC-PRESSURE CLASS, APPLICABLE SEALING REQUIREMENTS, MATERIALS INVOLVED, DUCT SUPPORT INTERVALS, AND OTHER PROVISIONS IN SMACNA'S "HVAC DUCT CONSTRUCTION STANDARDS - METAL AND FLEXIBLE." FITTINGS AND/OR JOINTS OF TWO DIFFERENT GAUGES, CONNECTED JOINT RATING SHALL MEET MORE STRINGENT CONDITIONS.														
						7.D.3.	USE THE FOLLOWING SMACNA TRANSVERSE (GIRTH) JOINTS														
						7.E.	DUCT SUPPORTS:														
						7.E.1.	RIGID ROUND, RECTANGULAR, AND FLAT OVAL METAL DUCTS SHALL BE INSTALLED WITH SUPPORT SYSTEMS INDICATED IN SMACNA'S "HVAC DUCT CONSTRUCTION STANDARDS" SECTION 5 TABLES 5-1, 5-2 AND 5-3 AND FIGURE 5-10 TO 5-10. THEY SHALL BE INSTALLED AS REQUIRED TO MAINTAIN ALIGNMENT. HORIZONTAL DUCTS SHALL HAVE A SUPPORT WITHIN 2 FEET OF EACH ELBOW AND WITHIN 4 FEET OF EACH BRANCH INTERSECTION. UPPER ATTACHMENTS TO STRUCTURES SHALL HAVE AN ALLOWABLE LOAD NOT MORE THAN ONE-FOURTH OF THE FAILURE LOAD.														
						7.E.2.	FLEXIBLE DUCT SHALL BE SUPPORTED AT THE MANUFACTURER'S RECOMMENDED INTERVALS BUT AT LEAST EVERY 5 FEET. MAXIMUM PERMISSIBLE SAG IS 1/2" PER FOOT OF SPACING BETWEEN SUPPORTS. A CONNECTION TO ANOTHER DUCT OR EQUIPMENT IS CONSIDERED A SUPPORT POINT.														
						7.F.	VOLUME DAMPERS: GALVANIZED STEEL, PER SMACNA "LOW VELOCITY MANUAL," EXCEPT PROVIDE BEARING AT ONE END OF DAMPER ROD AND QUADRANT, WITH LEVER AND LOCKSCREW AT OTHER END. FOR INSULATED DUCTS, QUADRANTS MOUNTED ON COLLAR TO CLEAR INSULATION. INSTALL WITH LEVERS ACCESSIBLE.														
						7.F.1.	PROVIDE MANUAL VOLUME DAMPERS TO PROPERLY PROVIDE MANUAL BALANCING VOLUME DAMPERS AS REQUIRED TO PROPERLY BALANCE THE AIR DISTRIBUTION SYSTEM. IF THE LOCATION OF BALANCING DAMPERS ARE NOT DEFINED ON THE DRAWINGS, THE FOLLOWING MINIMUM STANDARDS SHALL GOVERN:														
						7.F.1.A.	LOW PRESSURE: ALL SUPPLY AIR MAIN BRANCHES FROM TRUNK, EACH SPLIT, AND ALL SUB-BRANCHES FROM MAINS SHALL BE PROVIDED WITH BALANCING DAMPERS.														
						7.F.1.B.	LOW PRESSURE: ALL EXHAUST AND RETURN BRANCHES FROM TRUNK, EACH SPLIT AND ALL SUB-BRANCHES FROM MAINS SHALL BE PROVIDED WITH BALANCING DAMPERS.														
						7.F.1.C.	AS NOTED ON PLANS														
						7.G.	FLEXIBLE DUCTS:														
						7.G.1.	FLEXIBLE DUCT SHALL BE USED ONLY FOR FINAL CONNECTIONS TO OUTLETS, SIX FOOT LENGTH MAXIMUM WITH GRADUAL BENDS OR OFFSETS. ELBOWS SHALL BE SUPPORTED BY A MANUFACTURERS PACKAGED ELBOW SUPPORT (FLEXFLOW).														
						7.G.2.	TEAR RESISTANT, RUGGED FLEXIBLE DUCT DESIGNED FOR HIGH PRESSURE ENGINEERED HVAC SYSTEMS. UL181 CLASS I INSULATED AND NON-INSULATED AIR DUCT FABRICATED WITH A UNIQUE AND EXTREMELY TOUGH HEAVY COATED FIBERGLASS FABRIC. SOLID MECHANICAL UNION OF FABRIC AND CORROSION RESISTANT GALVANIZED STEEL. CREATE AN EXTRAORDINARY DURABLE SEAM. THERMALLY INSULATED TO AN R VALUE OF 8.0 AND OFFERED WITH A CHOICE OF FIRE RETARDANT POLYETHYLENE OR REINFORCED METALIZED PROTECTIVE VAPOR BARRIERS SUITABLE FOR UP TO 10 INCHES FOR SIZES UP TO 12 INCH DIAMETER, 6 INCHES FOR SIZES 14 TO 16 INCH DIAMETER, AND 4 INCHES FOR 18 TO 20 INCH DIAMETERS.														
						7.G.3.	FLEXIBLE DUCT CONNECTORS: CLAMPS SHALL BE STAINLESS STEEL BANDS WITH CADMIUM PLATED HEX SCREW TO TIGHTEN BAND WITH A WORKING LEVER. ACTION TO SUIT DUCT SIZE.														
						7.G.4.	MANUFACTURED BY FLEXMASTER TYPE 4, THERMALEX OR MODERMAK THESE PLANS IS TO BE AVAILABLE ON THE JOB SITE FROM THE DESIGN PROFESSIONAL GENERAL CONTRACTOR OR SUBCONTRACTOR OF THE BUILDING.														
						7.H.	ACCESS DOORS: INSULATED OR UNINSULATED, SAME AS DUCTS. ACCESS DOORS IF SUCH PLANS ARE NOT AVAILABLE ON THE JOB SITE FROM THE DESIGN PROFESSIONAL GENERAL CONTRACTOR OR SUBCONTRACTOR OF THE BUILDING.														
						7.H.1.	PROVIDE MINIMUM 20 INCH X 14 INCH ON MAIN DUCTS AND 20 INCH X 6 INCH ON BRANCH DUCTS, UNLESS OTHERWISE APPROVED, AT FIRE DAMPERS, AND AT ALL DUCT ACCESSORIES SUCH AS HUMIDIFIERS, DUCT SMOKE DETECTORS, AUTO DAMPERS, AND LOUVERS.														
						7.H.2.	ALL ACCESS DOORS TO BE HINGED, WITH LATCH SIMILAR TO VENTLOCK NO. 100.														
						7.I.	FLEXIBLE CONNECTIONS: NEOPRENE-COATED GLASS FABRIC, 30 OZ PER SQUARE YD WITH SEWED AND CEMENTED SEAMS, SIMILAR TO VENT FABRICS. PROVIDE WITH METAL COLLARS. ALLOW MINIMUM MOVEMENT OF 1 INCH.														
						7.J.	TURNING VANES: GALVANIZED STEEL SMALL DOUBLE-THICKNESS VANES WITH 2 INCH INSIDE RADIUS.														
						7.K.	ALL DUCT DIMENSIONS INDICATED ON PLANS ARE CLEAR INSIDE DIMENSIONS.														
						7.L.	AUTOMATIC DAMPERS: COMPLETE WITH LINKAGE AND ELECTRIC OPERATOR. OPPOSED BLADE DAMPER OR GALVANIZED STEEL MIN. 4 INCH, MAX. 8 INCH WIDE WITH COMPRESSIBLE EDGE SEALS TO PREVENT LEAKAGE. FACTORY-ASSEMBLE STEEL LINKAGE AND SHAFT WITH NYLON OR OIL-IMPREGNATED BRONZE BEARINGS. MOTOR WITH SUFFICIENT POWER TO LIMIT LEAKAGE TO 10 CFM PER SQUARE FEET. LINKAGE TO WITHSTAND LOAD EQUAL TO TWICE MAXIMUM OPERATING FORCE WITHOUT DEFLECTION. DAMPER MOUNTED IN WELDED STEEL CHANNEL FRAME.														
						7.M.	WIRE MESH SCREEN (WMS): NO. 16 USSG, 3/4 SQUARE MESH, IN 1 INCH WIDE GALVANIZED STEEL ENCLOSING FRAME. FLANGED DUCT OPENING TO RECEIVE FRAME.														
						7.N.	EXPOSED DUCTWORK:														
						7.N.1.	WHERE DUCTWORK IS INDICATED TO BE EXPOSED TO VIEW IN OCCUPIED SPACES, PROVIDE MATERIALS WHICH ARE FREE FROM VISUAL IMPERFECTIONS, INCLUDING PITTINGS, SEAM MARKS, STAINS, DISCOLORATIONS, AND OTHER IMPERFECTIONS. PROVIDE FINISHES WHICH WILL ALLOW PAINTING. PROVIDE FLAT TYPE SEAMS AND JOINTS FOR ALL EXPOSED DUCT CONSTRUCTION.														
						8.	AIR OUTLETS:														
						8.A.	GENERAL:														
						8.A.1.	MARGIN TYPES, COLORS, FINISH AND METHODS OF ATTACHMENT FOR ALL DIFFUSERS, GRILLES AND REGISTERS SHALL BE COORDINATED WITH ARCHITECTURAL CEILING AND WALL DETAILS AND SPECIFICATIONS. FINISH SHALL MATCH COLOR SAMPLE AS APPROVED.														
						8.A.2.	FRAME TYPE SUITABLE FOR MOUNTING IN CEILING OR WALL CONSTRUCTION AS INDICATED ON ARCHITECTURAL PLANS.														
						8.A.3.	EXACT LOCATION OF ALL AIR OUTLETS AS PER ARCHITECTURAL PLANS.														
						8.A.4.	PROVIDE MOUNTING AND BLOCKING														
						8.A.5.	SUITABLE FOR OPERATION AT 20% EXCESS AND 20% LESS THAN NOTED CAPACITY FOR CONSTANT VOLUME SYSTEMS AND AT 20% EXCESS AND 60% LESS THAN NOTED CAPACITY FOR VARIABLE VOLUME SYSTEMS.														
						8.A.6.	MANUFACTURER RESPONSIBLE FOR EXAMINING APPLICATION OF EACH OUTLET AND GUARANTEE THAT EACH WILL PROVIDE REQUIRED NC LEVELS AND COMFORT SPACE CONDITIONS WITHOUT DRAFTS THROUGHOUT OPERATING RANGE.														
						8.A.7.	PROVIDE SHEETMETAL BLANK OFF AS REQUIRED FOR 1 WAY, 2 WAY OR 3 WAY DIFFUSERS, OR DIFFUSERS WITH PATTERNS IDENTIFIED ON DRAWINGS.														
						8.A.8.	PROVIDE BLANKING FOR PROPER COVERAGE AND BLOW WITHOUT PRODUCING OBJECTIONABLE NOISE OR AIR MOTION AT OCCUPIED LEVEL.														
						8.A.9.	MANUFACTURERS: SUBJECT TO COMPLIANCE WITH REQUIREMENTS, PROVIDE PRODUCTS BY ONE OF THE FOLLOWING:														
						8.A.9.A.	TITUS														
						8.A.9.B.	PRICE														
						8.B.	REGISTERS AND GRILLES														
						8.B.1.	RETURN AND EXHAUST REGISTERS: STEEL OR ALUMINUM ALLOY CONSTRUCTION.														
						9.	TESTING AND BALANCING														
						9.A.	ALL AIR AND WATER BALANCING SHALL BE BY AN INDEPENDENT CONTRACTOR NOT AFFILIATED WITH THE MECHANICAL CONTRACTOR AND IN ACCORDANCE WITH LOCAL STANDARDS. CONTRACTOR SHALL UTILIZE BASE BUILDING BALANCING CONTRACTOR OR APPROVED EQUAL, CONTACT BUILDING MANAGEMENT.														
						9.B.	CONTRACTOR TO BALANCE ENTIRE SYSTEM TO AIR AND/OR WATER QUANTITIES AS SHOWN ON ALL RELATED DRAWINGS FOR THIS JOB, AND AS DESCRIBED HEREIN. BALANCING MUST BE DONE IN THE PRESENCE OF A BUILDING ENGINEER.														
						9.C.	AIR BALANCING SHALL BE ACCOMPLISHED BY ADJUSTMENT OF FANS AND BRANCH DAMPERS FOR MAJOR ADJUSTMENTS. AIR SUPPLY OUTLETS TO BE BALANCED TO A UNIFORM SUPPLY ACROSS ENTIRE FACE. ADJUSTMENT OF TERMINAL DAMPERS AND DEVICES SHALL BE FOR TRIM OR MINOR ADJUSTMENTS ONLY. THIS SHALL BE DONE TO PERMIT THE LEAST NOISE GENERATION IN THE TERMINAL AREAS AND UTILIZE MINIMUM FAN ENERGY.														
						9.D.	FANS, AIR HANDLING UNITS SHALL BE BALANCED TO WITHIN +5% OF THEIR DESIGN CAPACITIES. ALL OTHER AIR AND WATER QUANTITIES SHALL BE BALANCED TO WITHIN +10% OF THEIR DESIGN QUANTITIES.														
						9.E.	UPON COMPLETION OF THE INSTALLATION, THE CONTRACTOR SHALL REBALANCE ANY EXISTING PORTIONS OF THE AIR DISTRIBUTION SYSTEM AND WATER DISTRIBUTION SYSTEMS AFFECTED BY THE RENOVATION AND ALSO BALANCE ALL NEW WORK.														
						9.F.	IF DISCREPANCIES EXIST IN THE REPORT THAT REQUIRE FIELD VERIFICATION, THE TESTING AND BALANCING COMPANY IN THE PRESENCE OF THE ENGINEER SHALL VISIT THE JOBSITE FOR FIELD VERIFICATION OF THE REPORT.														
						9.G.	THE CONTRACTOR SHALL PROVIDE ALL LABOR, PRESSURE GAUGES, FLOW METERS, SHEAVES AND BELTS REQUIRED TO BALANCE SYSTEMS.														







	1	2	3	4	5	6	7	8	9	10	11	12	13	14	15	16	17	18	19	20	21
O	CONTENT, BUT NOT LESS THAN 2-1/2 BY 3/4 INCH.					ALL SAFETY WARNINGS POSTED BY THE MANUFACTURER.															
	17.A.4.	MINIMUM LETTER SIZE: 1/4 INCH FOR NAME OF UNITS IF VIEWING DISTANCE IS LESS THAN 24 INCHES (600 MM), 1/2 INCH FOR VIEWING DISTANCES UP TO 72 INCHES, AND PROPORTIONATELY LARGER LETTERING FOR GREATER VIEWING DISTANCES. INCLUDE SECONDARY LETTERING TWO-THIRDS TO THREE-FOURTHS THE SIZE OF PRINCIPAL LETTERING.					18.E.5.	WARRANTY													
N	17.A.5.	FASTENERS: STAINLESS-STEEL RIVETS OR SELF-TAPPING SCREWS.					18.E.5.A.	SUBMIT, FOR OWNER'S ACCEPTANCE, MANUFACTURER'S STANDARD WARRANTY DOCUMENT EXECUTED BY AUTHORIZED COMPANY OFFICIAL. MANUFACTURER'S WARRANTY IS IN ADDITION TO, AND NOT A LIMITATION OF, OTHER RIGHTS OWNER MAY HAVE UNDER CONTRACT DOCUMENTS. THE WARRANTY OF THIS EQUIPMENT IS TO BE FREE FROM DEFECTS IN MATERIAL AND WORKMANSHIP FOR A PERIOD OF 24 MONTHS FROM THE PURCHASE DATE. ANY UNITS OR PARTS, WHICH PROVE DEFECTIVE DURING THE WARRANTY PERIOD, WILL BE REPLACED AT THE MANUFACTURERS' OPTION WHEN RETURNED TO THE MANUFACTURER, TRANSPORTATION PREPAID.													
	17.A.6.	ADHESIVE: CONTACT-TYPE PERMANENT ADHESIVE, COMPATIBLE WITH LABEL AND WITH SUBSTRATE.					18.E.5.B.	MOTOR WARRANTY IS WARRANTED BY THE MOTOR MANUFACTURER FOR A PERIOD OF ONE YEAR. SHOULD MOTORS FURNISHED PROVE DEFECTIVE DURING THIS PERIOD, THEY SHOULD BE RETURNED TO THE NEAREST AUTHORIZED MOTOR SERVICE STATION.													
M	17.A.7.	LABEL CONTENT: INCLUDE EQUIPMENT'S DRAWING DESIGNATION OR UNIQUE EQUIPMENT NUMBER, DRAWING NUMBERS WHERE EQUIPMENT IS INDICATED (PLANS, DETAILS, AND SCHEDULES), PLUS THE SPECIFICATION SECTION NUMBER AND TITLE WHERE EQUIPMENT IS SPECIFIED.					18.E.5.C.	EQUIPMENT													
	17.A.8.	EQUIPMENT LABEL SCHEDULE: FOR EACH ITEM OF EQUIPMENT TO BE LABELED, ON 8-1/2-BY-11-INCH BOND PAPER. TABULATE EQUIPMENT IDENTIFICATION NUMBER AND IDENTIFY DRAWING NUMBERS WHERE EQUIPMENT IS INDICATED (PLANS, DETAILS, AND SCHEDULES), PLUS THE SPECIFICATION SECTION NUMBER AND TITLE WHERE EQUIPMENT IS SPECIFIED. EQUIPMENT SCHEDULE SHALL BE INCLUDED IN OPERATION AND MAINTENANCE DATA.					18.E.6.	EQUIPMENT													
L	17.B.	PIPE AND DUCT LABELS					18.E.6.A.	BASE AIR SOURCE HEAT PUMP PERFORMANCE AT STANDARD CONDITIONS.													
	17.B.1.	PIPE AND DUCT LABELS SHALL BE INSTALLED AT MAXIMUM INTERVALS OF 50 FEET ON STRAIGHT RUNS AND 25 FEET IN AREAS OF CONGESTED PIPING AND EQUIPMENT.					18.E.6.B.	EACH HEAT PUMP SHALL BE DIRECT DRIVEN AND PROVIDED WITH INVERTER OR OTHER VARIABLE SPEED CONTROL.													
K	17.B.2.	GENERAL REQUIREMENTS FOR MANUFACTURED PIPE LABELS: PREPRINTED, COLOR-CODED, WITH LETTERING INDICATING SERVICE, AND SHOWING FLOW DIRECTION.					END OF SECTION														
	17.B.3.	SELF-ADHESIVE PIPE AND DUCT LABELS: PRINTED PLASTIC WITH CONTACT-TYPE, PERMANENT ADHESIVE BACKING.																			
J	17.B.4.	PIPE AND DUCT LABEL CONTENTS: INCLUDE IDENTIFICATION OF PIPING SERVICE USING SAME DESIGNATIONS OR ABBREVIATIONS AS USED ON DRAWINGS, PIPE SIZE, AND AN ARROW INDICATING FLOW DIRECTION.																			
	17.B.4.A.	FLOW-DIRECTION ARROWS: INTEGRAL WITH PIPING OR DUCT SYSTEM SERVICE LETTERING TO ACCOMMODATE BOTH DIRECTIONS, OR AS SEPARATE UNIT ON EACH PIPE OR DUCT LABEL TO INDICATE FLOW DIRECTION.																			
I	17.B.4.B.	LETTERING SIZE: AT LEAST 1-1/2 INCHES HIGH.																			
	17.C.	VALVE TAGS																			
H	17.C.1.	INSTALL TAGS ON VALVES AND CONTROL DEVICES IN PIPING SYSTEMS. EXCEPT CHECK VALVES; VALVES WITHIN FACTORY-FABRICATED EQUIPMENT UNITS; SHUTOFF VALVES; FAUCETS; CONVENIENCE AND LAWN-WATERING HOSE CONNECTIONS; AND HVAC TERMINAL DEVICES AND SIMILAR ROUGHING-IN CONNECTIONS OF END-USE FIXTURES AND UNITS. LIST TAGGED VALVES IN A VALVE SCHEDULE.																			
	17.C.2.	VALVE TAGS: STAMPED OR ENGRAVED WITH 1/4-INCH LETTERS FOR PIPING SYSTEM ABBREVIATION AND 1/2-INCH NUMBERS.																			
G	17.C.2.A.	TAG MATERIAL: BRASS, 0.032-INCH MINIMUM THICKNESS, AND HAVING PREDRILLED OR STAMPED HOLES FOR ATTACHMENT HARDWARE.																			
	17.C.2.B.	FASTENERS: BRASS WIRE-LINK OR BEADED CHAIN; OR S-HOOK.																			
F	17.D.	VALVE SCHEDULES																			
	17.D.1.	FOR EACH PIPING SYSTEM, ON 8-1/2-BY-11-INCH BOND PAPER, TABULATE VALVE NUMBER, PIPING SYSTEM, SYSTEM ABBREVIATION (AS SHOWN ON VALVE TAG), LOCATION OF VALVE (ROOM OR SPACE), NORMAL-OPERATING POSITION (OPEN, CLOSED, OR MODULATING), AND VARIATIONS FOR IDENTIFICATION. MARK VALVES FOR EMERGENCY SHUTOFF AND SIMILAR SPECIAL USES. VALVE TAG SCHEDULE SHALL BE INCLUDED IN OPERATION AND MAINTENANCE DATA.																			
E	18.	EQUIPMENT																			
	18.A.	PROVIDE ALL EQUIPMENT AND ACCESSORIES OF THE SIZES AND CAPACITIES AS SCHEDULED AND AS INDICATED ON THE DRAWINGS.																			
D	18.B.	INSTALL EQUIPMENT IN ACCORDANCE WITH APPROVED SHOP DRAWINGS, MANUFACTURERS INSTRUCTIONS AND ALL CODES AND REGULATIONS WHICH APPLY.																			
	18.C.	PROVIDE EQUIPMENT SUPPORTS AND/OR MOUNTINGS AS INDICATED ON THE DRAWING, IN VIBRATION SPECIFICATION AND AS FOLLOWS:																			
C	18.C.1.	FLOOR MOUNTED EQUIPMENT - PROVIDE DIMENSIONS FOR A 4 INCH CONCRETE HOUSEKEEPING PAD WITH ALL REQUIRED WATERPROOFING TO THE CONSTRUCTION MANAGER.																			
	18.C.2.	EQUIPMENT ON FLOOR STANDS - PROVIDE FLOOR STAND OF STRUCTURAL STEEL OR STEEL PIPES AND FITTINGS ATTACHED TO FLOOR.																			
B	18.C.3.	ROOF MOUNTED EQUIPMENT - PROVIDE PREFABRICATED ISOLATED ROOF CURB WITH INTEGRAL VIBRATION ISOLATORS.																			
	18.C.4.	CEILING MOUNTED EQUIPMENT - PROVIDE SUPPORTS WITH APPROVED SUITABLE ANCHORS SUSPENDED DIRECTLY FROM BUILDING STEEL STRUCTURE.																			
A	18.C.5.	PROVIDE SUPPLEMENTAL STEEL AS REQUIRED TO ADEQUATELY SUPPORT THE EQUIPMENT LOAD.																			
	18.C.6.	EQUIPMENT SHALL BE INSTALLED WITH VIBRATION ISOLATION, REFER TO VIBRATION ISOLATION SECTION.																			
	18.D.	UP FRONT PURCHASE OF EQUIPMENT:																			
	18.D.1.	THE CONTRACTOR SHALL SUBMIT A LIST OF LONG LEAD TIME ITEMS THAT WILL AFFECT THE SCHEDULE OF THE PROJECT IF NOT PURCHASED IMMEDIATELY UP FRONT AT THE START OF THE PROJECT. THE MECHANICAL CONTRACTOR SHALL SUBMIT PROPOSED MANUFACTURER AND LEAD TIMES FOR ALL PROJECT EQUIPMENT AT TIME OF PROJECT AWARD.																			
	18.E.	DUCTED AIR SOURCE HEAT PUMP																			
	18.E.1.	BASIS OF DESIGN: MITSUBISHI																			
	18.E.2.	QUALITY ASSURANCE																			
	18.E.2.A.	PERFORMANCE RATINGS: AIR SOURCE HEAT PUMPS SHALL HAVE A MINIMUM HSPF OF 11.2, MINIMUM SEER OF 18.2 AND MINIMUM EER OF 11.2. THE COP AT 47°F OUTSIDE AIR TEMPERATURE SHALL BE NO LESS THAN 3.9. THE EQUIPMENT SHALL BE ENERGY STAR CERTIFIED AND LISTED ON THE NEEP COLD CLIMATE AIR SOURCE HEAT PUMP LIST.																			
	18.E.2.B.	MANUFACTURERS THAT DO NOT COMPLY WITH PARAGRAPH 18.E.1 MUST ALSO PROVIDE AT THE OWNER AND ENGINEER'S OPTION PERFORMANCE SUBMITTAL DATA, CONTROLS INTEGRATION SUBMITTAL, AND PERFORMANCE THAT MEETS OR EXCEED PARAGRAPH 18.E.2.B.																			
	18.E.3.	SUBMITTALS																			
	18.E.3.A.	PROVIDE DIMENSIONAL DRAWINGS AND PRODUCT DATA ON EACH AIR SOURCE HEAT PUMP AND INDOOR AIR HANDLING UNIT.																			
	18.E.3.B.	PROVIDE PERFORMANCE CURVES AT THE AHRI STANDARD RATING CONDITIONS.																			
	18.E.3.C.	STRICTLY ADHERE TO THE QUALITY ASSURANCE REQUIREMENTS AS STATED IN SECTION 1.4 OF THIS SPECIFICATION.																			
	18.E.4.	DELIVERY, STORAGE, AND HANDLING																			
	18.E.4.A.	DELIVER MATERIALS TO SITE IN MANUFACTURER'S ORIGINAL, UNOPENED CONTAINERS AND PACKAGING, WITH LABELS CLEARLY INDICATING MANUFACTURER, MATERIAL, PRODUCTS INCLUDED, AND LOCATION OF INSTALLATION.																			
	18.E.4.B.	STORE MATERIALS IN A DRY AREA INDOOR, PROTECTED FROM DAMAGE, AND IN ACCORDANCE WITH MANUFACTURER'S INSTRUCTIONS. FOR LONG TERM STORAGE, FOLLOW MANUFACTURER'S INSTALLATION, OPERATION AND MAINTENANCE MANUAL.																			
	18.E.4.C.	HANDLE AND LIFT AIR SOURCE HEAT PUMPS IN ACCORDANCE WITH THE MANUFACTURER'S INSTRUCTIONS. PROTECT MATERIALS AND FINISHES DURING HANDLING AND INSTALLATION TO PREVENT DAMAGE. FOLLOW																			

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DATE: 10-10-22  
BUILDING OFFICIAL: KS

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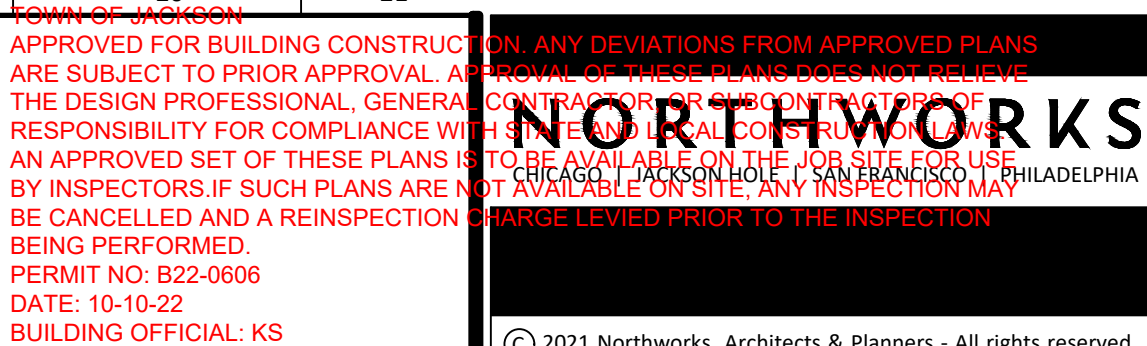
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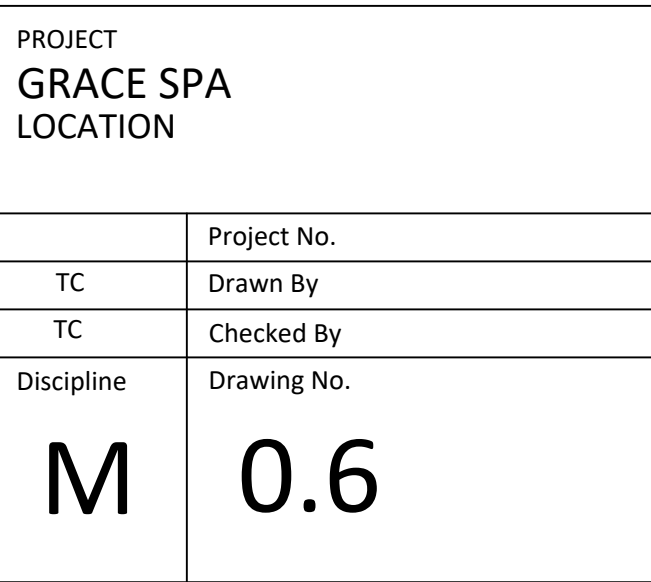
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Drawing Name

DETAILS

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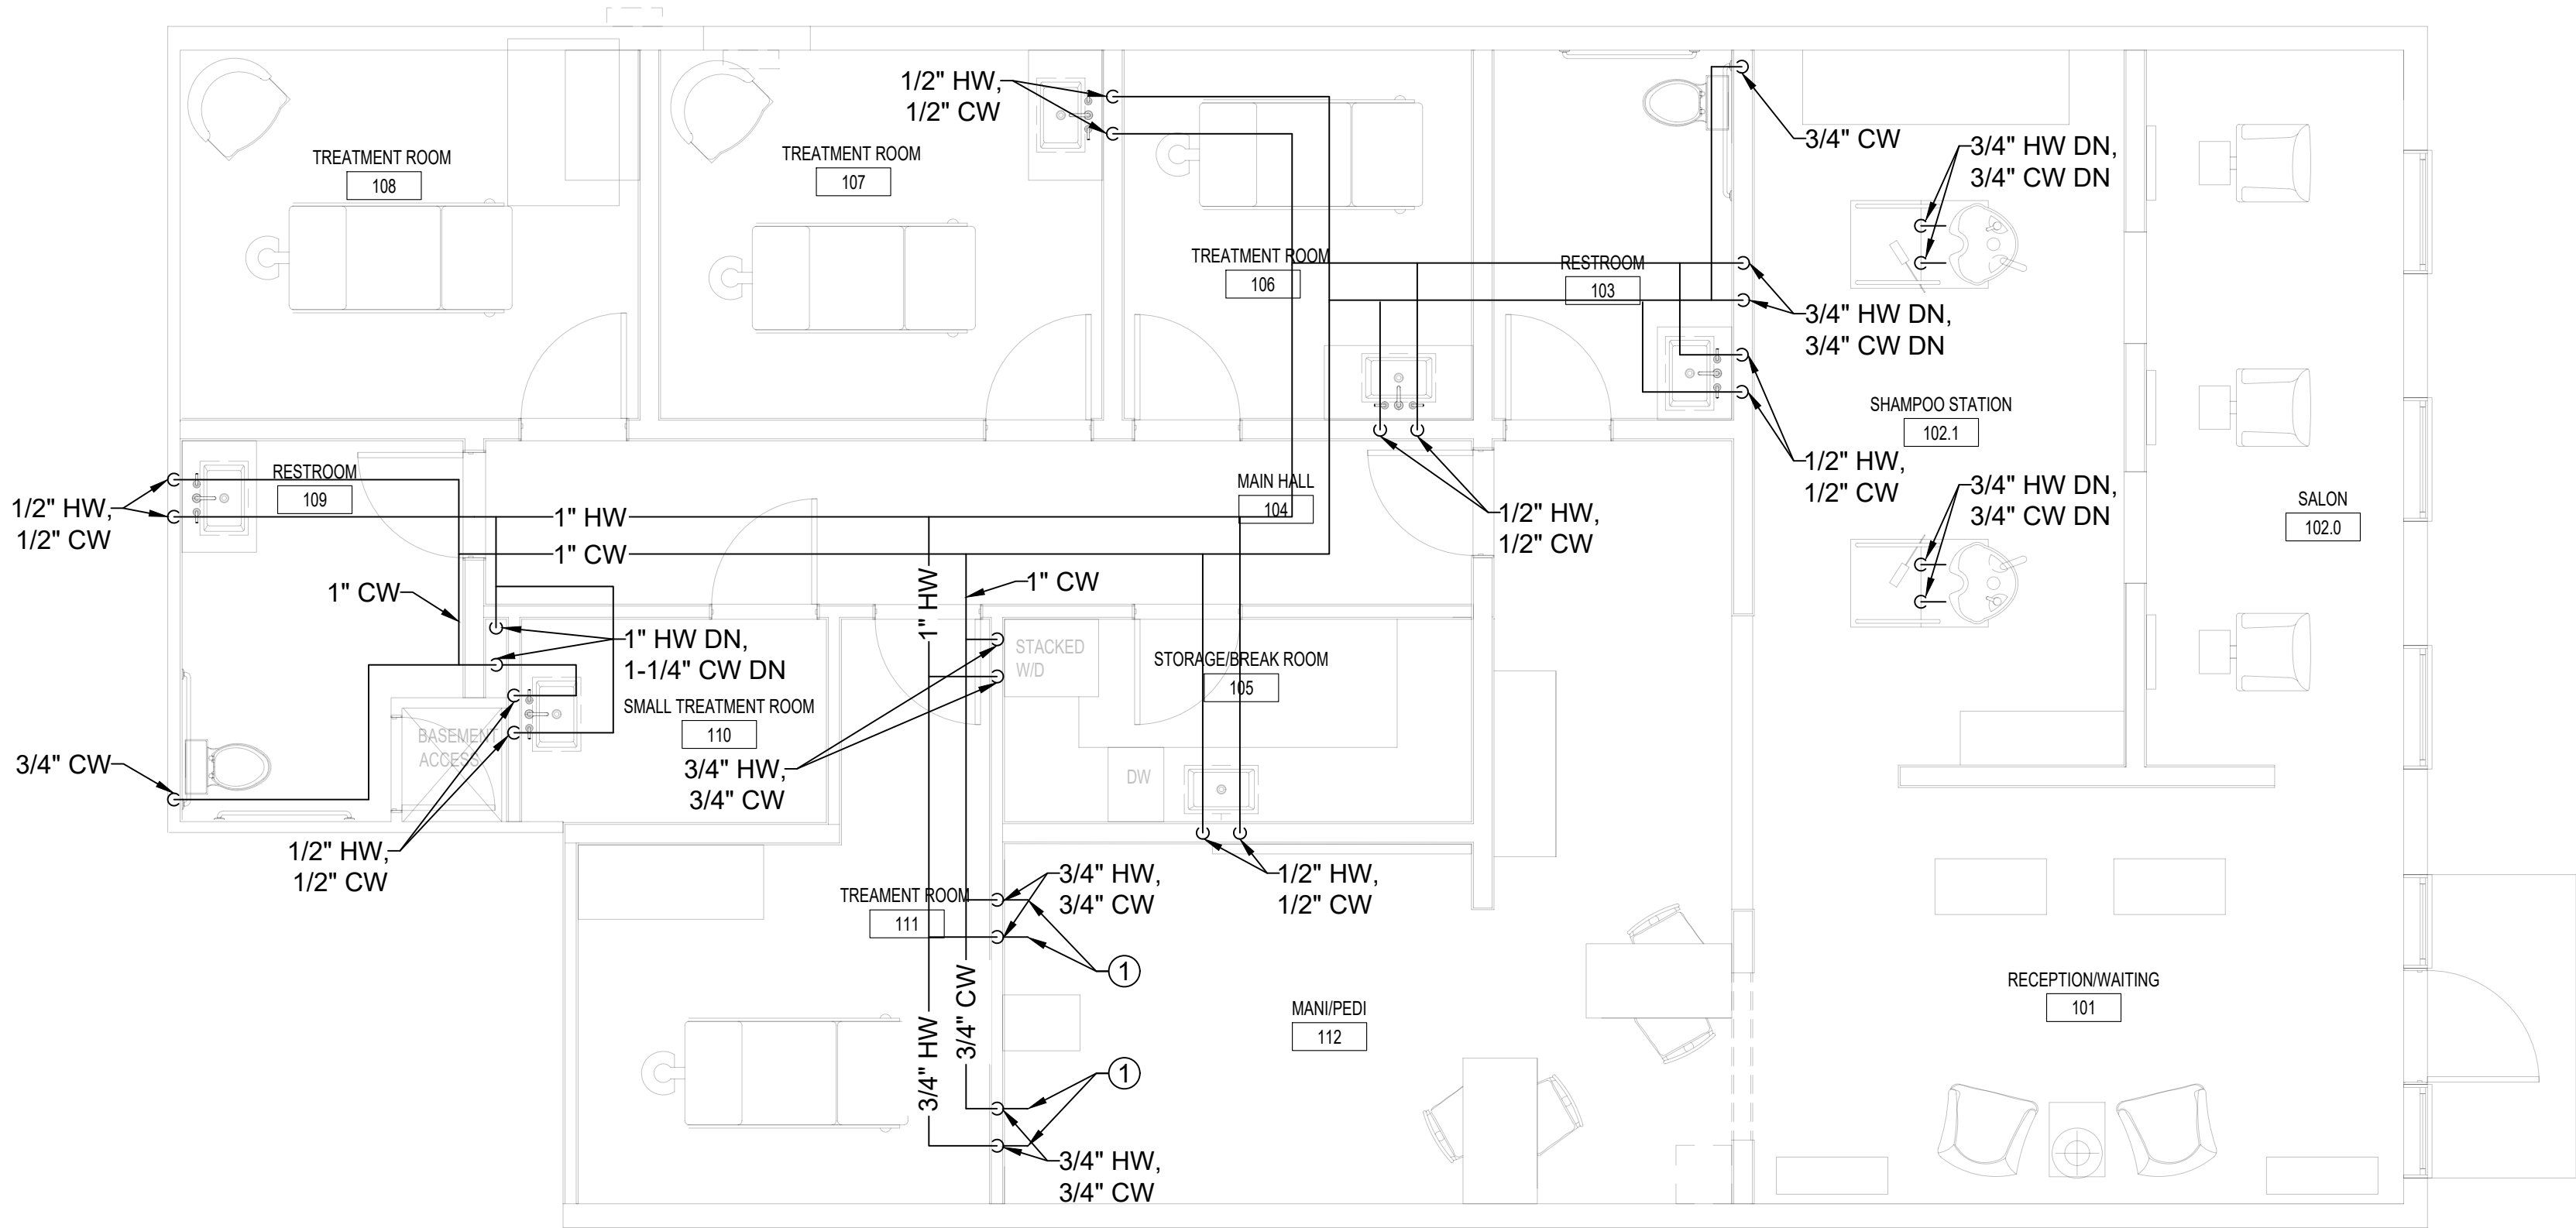
FIRST FLOOR MECHANICAL PLAN



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Drawing Name
BASEMENT DOMESTIC PLUMBING PLAN






1 FIRST FLOOR DOMESTIC PLUMBING  
SCALE: 1/4" = 1'-0" NORTH

- SHEET NOTES:**
- ROUTE ALL DOMESTIC WATER PIPING ABOVE DROP CEILING. COORDINATE WITH ELECTRICAL AND MECHANICAL SYSTEMS IN ACCORDANCE WITH THE 2021 INTERNATIONAL PLUMBING CODE WITH LOCAL AMENDMENTS.
  - DRAWINGS ARE DIAGRAMMATIC IN NATURE. ALL PIPE ROUTING AND INSTALLATION SHOULD BE VERIFIED IN FIELD PRIOR TO INSTALLATION.
  - PROVIDE SHUTOFF VALVES IN ALL DOMESTIC WATER PIPING SYSTEM BRANCHES IN WHICH BRANCH SERVE TWO OR MORE FIXTURES.
  - INSTALL ALL PIPING SO ALL VALVES, STRAINERS, UNIONS, TRAPS, FLANGES AND OTHER APPURTENANCES REQUIRING ACCESS ARE ACCESSIBLE.

- KEYED NOTES:**
- STUB OUT 3/4" DOMESTIC HOT AND COLD WATER LINES FOR PEDICURE STATIONS. VERIFY EXACT LOCATION IN FIELD. COORDINATE LOCATION AND REQUIREMENTS WITH OWNER PRIOR TO ROUGH-IN.
  - ALL DUCTWORK LOCATED IN THE BOILER ROOM TO BE MINIMUM THICKNESS OF 24 GAUGE GALVANIZED SHEET STEEL, INSULATED WITH R-8 FIRE-PROOF INSULATION.
  - PROVIDE CL WARD CRD-50 1-HOUR FIRE DAMPER WITH BOOT WHERE DUCT PENETRATES THE FLOOR ABOVE. INSTALL INTUMESCENT FIRE-CAULK AT ANY GAP BETWEEN BOOT AND FLOOR PENETRATION.
  - PROVIDE 1-HOUR RATED FIRE DAMPER AT FIRST FLOOR PENETRATION. INSTALL INTUMESCENT FIRE-CAULK AT ANY GAP BETWEEN BOOT AND FLOOR PENETRATION.
  - PROVIDE AND INSTALL CONDENSATE DISPOSAL LINE. ROUTE TO NEAREST INDIRECT DISPOSAL LOCATION.

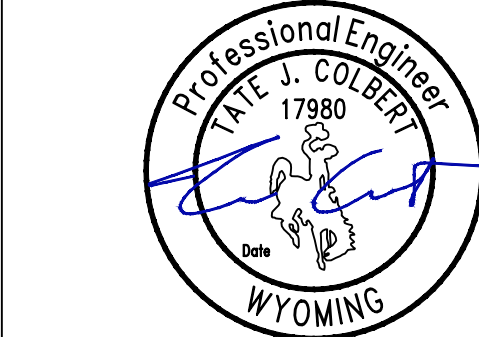


PROJECT  
GRACE SPA  
LOCATION

	Project No.
TC	Drawn By
TC	Checked By
Discipline	Drawing No.

P 1.1

Drawing Name  
FIRST FLOOR DOMESTIC PLUMBING  
PLAN

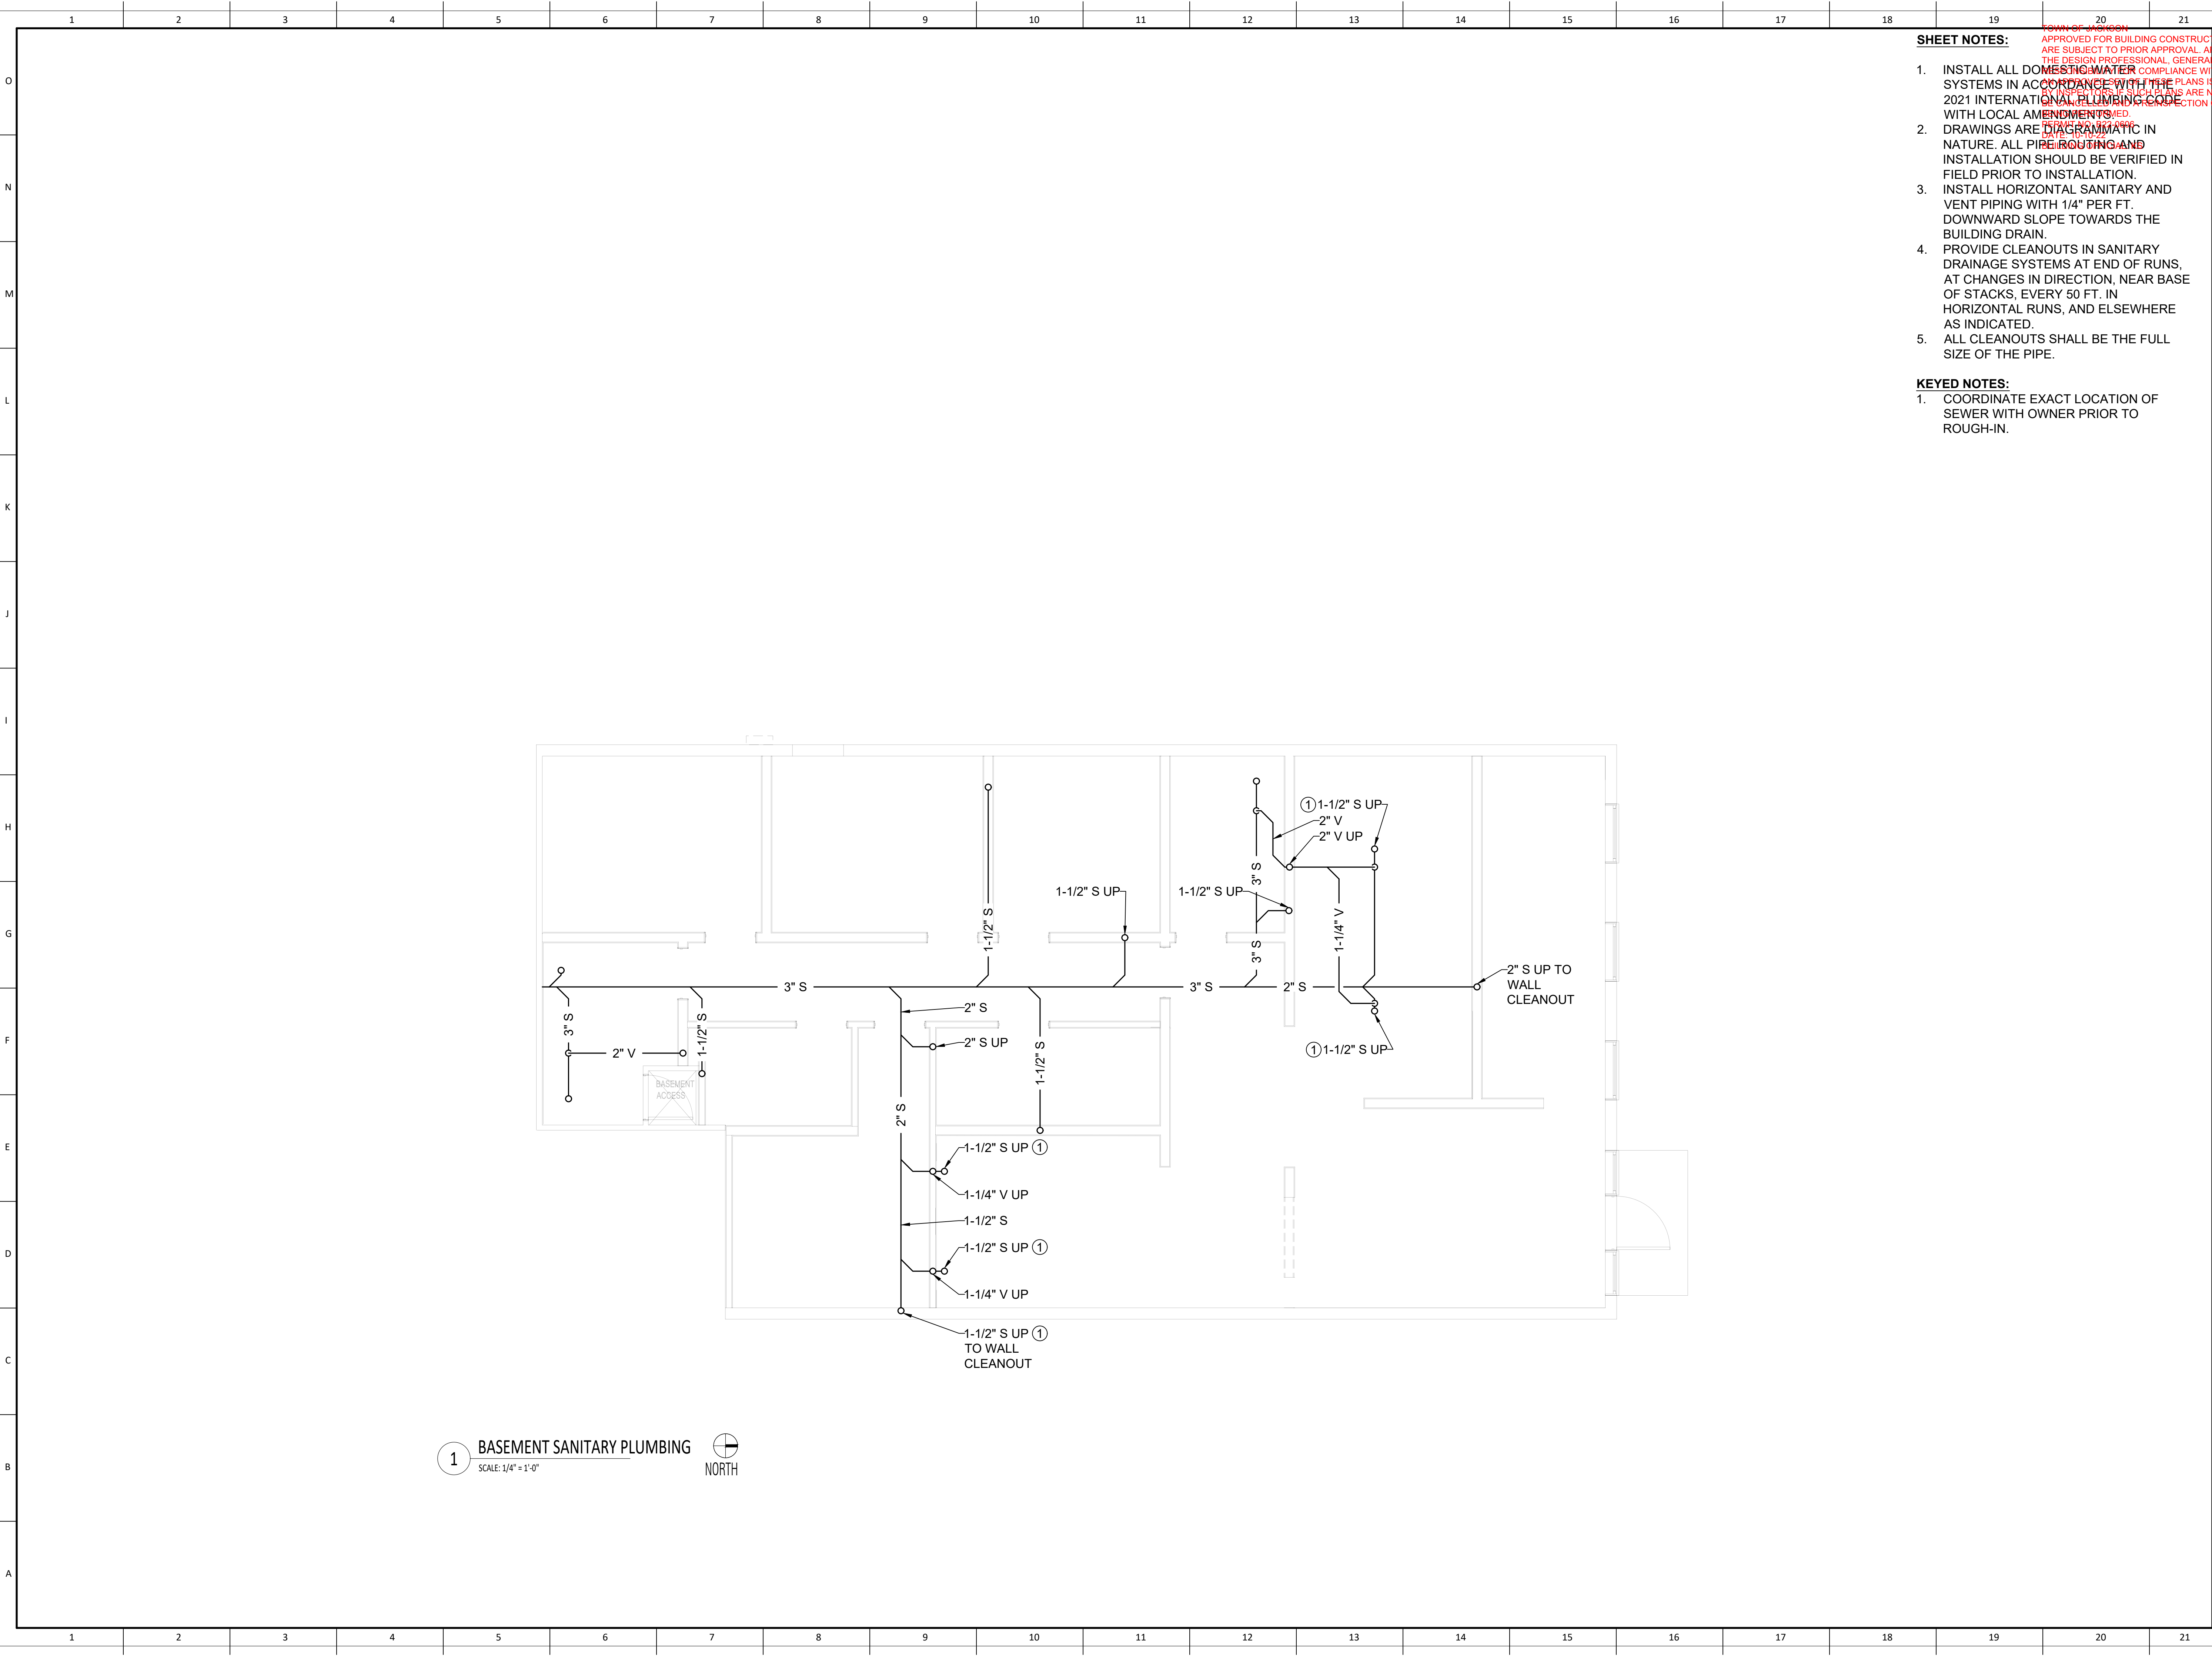

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**SHEET NOTES:**

1. INSTALL ALL DOMESTIC WATER SYSTEMS IN ACCORDANCE WITH THE 2021 INTERNATIONAL PLUMBING CODE WITH LOCAL AMENDMENTS.
2. DRAWINGS ARE DIAGRAMMATIC IN NATURE. ALL PIPE ROUTING AND INSTALLATION SHOULD BE VERIFIED IN FIELD PRIOR TO INSTALLATION.
3. INSTALL HORIZONTAL SANITARY AND VENT PIPING WITH 1/4" PER FT. DOWNWARD SLOPE TOWARDS THE BUILDING DRAIN.
4. PROVIDE CLEANOUTS IN SANITARY DRAINAGE SYSTEMS AT END OF RUNS, AT CHANGES IN DIRECTION, NEAR BASE OF STACKS, EVERY 50 FT. IN HORIZONTAL RUNS, AND ELSEWHERE AS INDICATED.
5. ALL CLEANOUTS SHALL BE THE FULL SIZE OF THE PIPE.

**KEYED NOTES:**

1. COORDINATE EXACT LOCATION OF SEWER WITH OWNER PRIOR TO ROUGH-IN.




1. INSTALL ALL DOMESTIC WATER SYSTEMS IN ACCORDANCE WITH THE 2021 INTERNATIONAL PLUMBING CODE WITH LOCAL AMENDMENTS.
2. DRAWINGS ARE DIAGRAMMATIC IN NATURE. ALL PIPE ROUTING AND INSTALLATION SHOULD BE VERIFIED IN FIELD PRIOR TO INSTALLATION.
3. INSTALL HORIZONTAL SANITARY AND VENT PIPING WITH 1/4" PER FT. DOWNWARD SLOPE TOWARDS THE BUILDING DRAIN.
4. PROVIDE CLEANOUTS IN SANITARY DRAINAGE SYSTEMS AT END OF RUNS, AT CHANGES IN DIRECTION, NEAR BASE OF STACKS, EVERY 50 FT. IN HORIZONTAL RUNS, AND ELSEWHERE AS INDICATED.
5. ALL CLEANOUTS SHALL BE THE FULL SIZE OF THE PIPE.

1. CONNECT VENT PIPING TO EXISTING VENT THROUGH ROOF. CONTRACTOR SHALL COORDINATE EXACT LOCATION IN FIELD AND INSPECT EXISTING VENT PIPE FOR APPROPRIATE SIZE AND CONDITION.

**ON ANY DEVIATIONS FROM APPROVED PLANS  
PROVIDED THESE PLANS DOES NOT RELIEVE  
CONTRACTOR FROM CONSTRUCTION PERIOD  
4-1-2019 TO 4-30-2019. CONTRACTOR SHALL  
BE AVAILABLE ON SITE FOR SITE FOR USE  
NOT AVAILABLE ON SITE. ANY INSPECTION MAY  
BE CHARGE LEVIED PRIOR TO THE INSPECTION**

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<p>PROJECT <b>GRACE SPA</b> LOCATION</p>	
	Project No.
TC	Drawn By
TC	Checked By
Discipline	Drawing No.
P	1.3
Drawing Name	
<b>FIRST FLOOR SANITARY PLUMBING PLAN</b>	

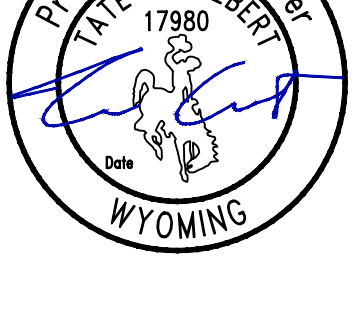

ELECTRICAL LEGEND - LIGHTING	
<p>REFERENCE FUTURE SCHEDULE FOR MOUNTING TYPE, MOUNTING HEIGHT, AND FUTURE TYPE.</p> <p>DOUBLE FACE EXIT SIGN, CEILING MOUNTED, PROVIDE UNSWITCHED CONDUCTOR.</p> <p>WALL MOUNTED DOUBLE FACE EXIT SIGN PROVIDE UNSWITCHED CONDUCTOR. MOUNT AT 4'-0" UNO.</p> <p>SINGLE FACE EXIT SIGN, CEILING MOUNTED, PROVIDE UNSWITCHED CONDUCTOR. MOUNT AT 4'-0" UNO.</p> <p>WALL MOUNTED SINGLE FACE EXIT SIGN PROVIDE UNSWITCHED CONDUCTOR. MOUNT AT 4'-0" UNO.</p> <p>OR LOW VOLTAGE, MOMENTARY OVERRIDE</p> <p>VACANCY SENSOR</p> <p>SUPERSCRIPT INDICATES LIGHTS TO BE SWITCHED TOGETHER</p> <p>1'X1' LIGHT FIXTURE.</p> <p>1'X1' LIGHT FIXTURE, PROVIDE EMERGENCY BATTERY BACKUP CONNECTED TO AN UNSWITCHED CONDUCTOR.</p> <p>TRACK LIGHT</p> <p>1'X1' LIGHT FIXTURE.</p> <p>1'X1' LIGHT FIXTURE, PROVIDE EMERGENCY BATTERY BACKUP CONNECTED TO AN UNSWITCHED CONDUCTOR.</p> <p>2'X1' LIGHT FIXTURE.</p> <p>2'X1' LIGHT FIXTURE, PROVIDE EMERGENCY BATTERY BACKUP CONNECTED TO AN UNSWITCHED CONDUCTOR.</p> <p>2'X2' LIGHT FIXTURE.</p> <p>2'X2' LIGHT FIXTURE, PROVIDE EMERGENCY BATTERY BACKUP CONNECTED TO AN UNSWITCHED CONDUCTOR.</p> <p>DIRECT/INDIRECT LIGHT FIXTURE. SEE SCHEDULE FOR LENGTH.</p> <p>DIRECT/INDIRECT LIGHT FIXTURE. SEE SCHEDULE FOR LENGTH. PROVIDE EMERGENCY BATTERY BACKUP CONNECTED TO AN UNSWITCHED CONDUCTOR.</p> <p>STRIP LIGHT FIXTURE. SEE SCHEDULE FOR LENGTH.</p> <p>STRIP LIGHT FIXTURE. SEE SCHEDULE FOR LENGTH. PROVIDE EMERGENCY BATTERY BACKUP CONNECTED TO AN UNSWITCHED CONDUCTOR.</p> <p>WALL MOUNTED LIGHT FIXTURE.</p> <p>WALL MOUNTED LIGHT FIXTURE, PROVIDE EMERGENCY BATTERY BACKUP CONNECTED TO AN UNSWITCHED CONDUCTOR.</p> <p>RECESSED LIGHT FIXTURE.</p> <p>RECESSED LIGHT FIXTURE, PROVIDE EMERGENCY BATTERY BACKUP CONNECTED TO AN UNSWITCHED CONDUCTOR.</p> <p>ROUND LIGHT FIXTURE.</p> <p>ROUND EMERGENCY LIGHT FIXTURE, PROVIDE EMERGENCY BATTERY BACKUP CONNECTED TO AN UNSWITCHED CONDUCTOR.</p> <p>WALL MOUNTED LIGHT FIXTURE.</p> <p>WALL MOUNTED EMERGENCY LIGHT FIXTURE, PROVIDE EMERGENCY BATTERY BACKUP CONNECTED TO AN UNSWITCHED CONDUCTOR.</p> <p>POLE LIGHT 1 HEAD WITH POLE</p> <p>TIME CLOCK</p> <p>PHOTO CONTROL, CELL LOCATED 12" ABOVE ROOF FACING NORTH.</p> <p>OCCUPANCY SENSOR, PROVIDE RELAYS AND POWER PACKS AS REQUIRED.</p> <p>LED DRIVER</p> <p>EMERGENCY EGRESS LIGHTING WITH OUT FUTURE HEADS, CONNECT TO AN UNSWITCHED CONDUCTOR.</p> <p>EMERGENCY EGRESS LIGHTING, CONNECT TO AN UNSWITCHED CONDUCTOR.</p> <p>WALL MOUNTED SINGLE FACE EXIT SIGN WITH EMERGENCY EGRESS LIGHTING, PROVIDE UNSWITCHED CONDUCTOR. MOUNT AT 4'-0" UNO.</p> <p>CEILING MOUNTED, SINGLE FACE EXIT SIGN WITH EMERGENCY EGRESS LIGHTING, PROVIDE UNSWITCHED CONDUCTOR.</p> <p>CEILING MOUNTED, DOUBLE FACE EXIT SIGN WITH EMERGENCY EGRESS LIGHTING, PROVIDE UNSWITCHED CONDUCTOR.</p> <p>xxx INDICATES FIXTURE TYPE. REFER TO FIXTURE SCHEDULE.</p> <p>exterior wall pack</p> <p>EMERGENCY EXTERIOR WALL PACK, PROVIDE EMERGENCY BATTERY BACKUP CONNECTED TO AN UNSWITCHED CONDUCTOR</p>	

DEVICES	
<p>2 DOUBLE POLE</p> <p>3 3-WAY</p> <p>4 4-WAY</p> <p>K KETED</p> <p>P PILOT LIGHT</p> <p>D DIMMER</p> <p>HP HORSEPOWER RATED</p> <p>LV LOW VOLTAGE</p> <p>OS OCCUPANCY SENSOR</p> <p>OR LOW VOLTAGE, MOMENTARY OVERRIDE</p> <p>VS VACANCY SENSOR</p> <p>4 SUPERSCRIPT INDICATES LIGHTS TO BE SWITCHED TOGETHER</p> <p>DUAL LEVEL SWITCHING, INSIDE AND OUTSIDE LAMPS OF FIXTURE TO BE SWITCHED SEPARATELY.</p> <p>DUAL LEVEL SWITCHING WITH OCCUPANCY SENSOR, INSIDE AND OUTSIDE LAMPS OF FIXTURE TO BE SWITCHED SEPARATELY.</p> <p>OCCUPANCY SENSOR WITH MANUAL DIMMING, SET FOR 50% AUTOMATIC ON, AUTOMATIC OFF, WITH MANUAL DIMMING.</p> <p>SINGLE CONVENIENCE OUTLET, 118" AFF UNO</p> <p>FLOOR MOUNT SINGLE CONVENIENCE OUTLET</p> <p>DUPLEX CONVENIENCE OUTLET, 118" AFF UNO</p> <p>FLOOR MOUNT DUPLEX CONVENIENCE OUTLET</p> <p>EMERGENCY DUPLEX CONVENIENCE OUTLET, 118" AFF UNO</p> <p>SWITCHED DUPLEX CONVENIENCE OUTLET, 118" AFF UNO</p> <p>FLOOR MOUNT SWITCHED DUPLEX CONVENIENCE OUTLET</p> <p>USB DUPLEX CONVENIENCE OUTLET, 118" AFF UNO</p> <p>USB FOURPLEX CONVENIENCE OUTLET, 118" AFF UNO</p> <p>FOURPLEX CONVENIENCE OUTLET, 118" AFF UNO</p> <p>FLOOR MOUNT FOURPLEX CONVENIENCE OUTLET</p> <p>CONNECTION POINT TO EQUIPMENT SPECIFIED, ELECTRICAL CONTRACTOR TO SUPPLY RACEWAY AND CONDUCTORS AND MAKE FINAL CONNECTION TO EQUIPMENT UNDER THIS SECTION UNO.</p> <p>FLOOR MOUNTED CONNECTION POINT, SEE NOTE ABOVE FOR REQUIREMENTS</p> <p>FLOOR MOUNTED JUNCTION BOX</p> <p>JUNCTION BOX</p> <p>WALL MOUNTED PUSH BUTTON, MOUNT AT SWITCH HEIGHT UNO</p> <p>WALL MOUNTED PUSH BUTTON, MOUNT AT SWITCH HEIGHT UNO</p> <p>WALL MOUNTED PUSH BUTTON, MOUNT AT SWITCH HEIGHT UNO</p> <p>MOTOR STARTER/CONTACTOR, SIZE/POLES NEMA 1 UNO AS INDICATED, NEMA 1 UNO</p> <p>COMBINATION STARTER AND DISCONNECT, SIZE/POLES, STARTER SIZE AS INDICATED, NEMA 1 UNO</p> <p>FUSED DISCONNECT SWITCH, SIZE/POLES, FUSE SIZES AS INDICATED, NEMA 1 UNO</p> <p>NON-FUSED DISCONNECT SIZE/POLES AS INDICATED, NEMA 1 UNO</p> <p>THERMOSTAT, 118" AFF PROVIDE CONDUIT, 1 BOX, CONDUCTORS AS REQUIRED TO CONTROL ASSOCIATED UNITS. UNO COORDINATE WITH DIVISION 16.</p> <p>HUMIDISTAT, 118" AFF PROVIDE CONDUIT, 1 BOX, CONDUCTORS AS REQUIRED TO CONTROL ASSOCIATED UNITS.</p> <p>POWER POLE - DUAL CHANNEL</p> <p>RECESSED ENTERTAINMENT BOX</p> <p>TRANSFORMER</p> <p>PANELBOARD, SEE SCHEDULE FOR TYPE</p> <p>EQUIPMENT CABINET, SURFACE MOUNTED</p> <p>EQUIPMENT CABINET FLUSH MOUNTED</p> <p>SURFACE MULTI-OUTLET RACEWAY</p> <p>MECHANICAL EQUIPMENT CALL OUT</p> <p>KITCHEN EQUIPMENT CALLOUT</p>	

ONE LINE	
<p>DELTA WYE TRANSFORMER UNO</p> <p>PANEL BOARD, SEE SCHEDULE FOR TYPE AND SIZE</p> <p>CIRCUIT BREAKER, SIZE AND POLES INDICATED</p> <p>FUSE, SIZE AND TYPE INDICATED, PROVIDE FUSE FOR EACH POLE</p> <p>INTERRUPTER SWITCH, SIZE AND POLES INDICATED</p> <p>FUSED SWITCH, SIZE/POLES AND FUSE SIZE INDICATED</p> <p>DRAW OUT CIRCUIT BREAKER, SIZE AND POLES INDICATED</p> <p>INDIVIDUAL BREAKER WITH SHUNT TRIP, SIZE AND POLES INDICATED, NEMA 1 UNO</p> <p>INDIVIDUAL BREAKER, SIZE AND POLES INDICATED, NEMA 1 UNO</p> <p>GROUND FAULT PROTECTION</p> <p>TRANSIENT VOLTAGE SURGE SUPPRESSION</p> <p>ADJUSTABLE BREAKER SETTINGS (PER SPECIFICATIONS)</p> <p>1" LONG TIME</p> <p>3" SHORT TIME</p> <p>7" INSTANTANEOUS</p> <p>15" ENERGY REDUCING MAINTENANCE SWITCH STATUS INDICATOR</p> <p>GROUND</p> <p>SHUNT TRIP COIL</p> <p>MOTOR</p> <p>DISCONNECT SWITCH, SIZE AND POLES INDICATED, NEMA 1 UNO</p> <p>OVERHEAD SERVICE DROP</p> <p>GENERATOR SET, MAIN BREAKER SIZE INDICATED</p> <p>AUTOMATIC TRANSFER SWITCH (ATS)</p> <p>METER AND BASE</p> <p>NEUTRAL</p> <p>DRY TYPE TRANSFORMER</p> <p>PAD MOUNT TRANSFORMER</p>	

FIRE ALARM	
<p>PULL STATION, 118" AFF WITH PRE-ALARM COVER</p> <p>FIRE ALARM HORN, 118" AFF UNO</p> <p>FIRE ALARM STROBE, 118" AFF UNO, STROBE INTENSITY INDICATED, 118" AFF UNO</p> <p>FIRE ALARM HORN/STROBE, 118" AFF UNO, STROBE INTENSITY INDICATED, 118" AFF UNO</p> <p>FIRE ALARM BELL, 118" AFF UNO, 118" AFF UNO</p> <p>FIRE ALARM CHIME, 118" AFF UNO, 118" AFF UNO</p> <p>FIRE ALARM CHIMESTROBE, 118" AFF UNO, STROBE INTENSITY INDICATED, 118" AFF UNO</p> <p>SPEAKER STROBE, 118" AFF UNO, 118" AFF UNO</p> <p>END OF LINE RESISTOR</p> <p>FLOW SWITCH, PROVIDE MONITOR MODULE AS REQUIRED</p> <p>TAMPER SWITCH, PROVIDE MONITOR MODULE AS REQUIRED</p> <p>PRESSURE SWITCH, PROVIDE MONITOR MODULE AS REQUIRED</p> <p>FIRE SYSTEM ANNUNCIATOR, FLUSH MOUNTED, 118" AFF UNO</p> <p>POST INDICATOR VALVE, PROVIDE MONITOR MODULE AS REQUIRED</p> <p>ELECTROMAGNETIC DOOR HOLDER</p> <p>RELAY</p> <p>CONTROL MODULE</p> <p>MONITOR MODULE</p> <p>FIRE ALARM KNOX BOX</p> <p>FIRE ALARM CONTROL PANEL</p> <p>NAC EXTENDER PANEL</p> <p>FIRE SMOKE DAMPER</p> <p>LED INDICATOR LIGHT, CEILING MOUNTED UNO</p> <p>LED INDICATOR LIGHT WITH TEST SWITCH, CEILING MOUNTED UNO</p> <p>DUCT-MOUNTED SMOKE DETECTOR</p> <p>SMOKE DETECTOR, CEILING MOUNTED UNO</p> <p>H HEAT</p> <p>I IONIZATION</p> <p>D IN DUCT</p> <p>P PHOTOELECTRIC</p> <p>R RELAY</p> <p>W PROVIDE PROTECTIVE WIRE GUARD</p> <p>BEAM DETECTOR, SENDER &amp; RECEIVER</p>	

ELECTRICAL ABBREVIATIONS	
<p>A AMPERES</p> <p>AF 6" ABOVE BACKSPLASH</p> <p>AFG ABOVE FINISHED FLOOR</p> <p>AFG ABOVE FINISHED GRADE</p> <p>AF AMP FRAME</p> <p>AIC AMPS INTERRUPTING CAPACITY</p> <p>AT AUTOMATIC TRANSFER SWITCH</p> <p>ATS AMERICAN WIRE GAUGE</p> <p>BD BOTTOM OF DECK</p> <p>BS BOTTOM OF STRUCTURE</p> <p>C CEILING MOUNTED</p> <p>CD CONDUIT</p> <p>CB CIRCUIT BREAKER</p> <p>CF COMPACT FLUORESCENT</p> <p>CNT CIRCUIT</p> <p>CO CONDUIT ONLY, PROVIDE PULL LINE</p> <p>CT CURRENT TRANSFORMER</p> <p>CTL CONTROL</p> <p>DC DIRECT CURRENT</p> <p>DEM DEMOLITION</p> <p>DET DETAIL</p> <p>DTT DOUBLE TWIN TUBE</p> <p>E EMERGENCY</p> <p>EL EXISTING</p> <p>ELC ELECTRICAL CONTRACTOR</p> <p>EL EMERGENCY LIGHT</p> <p>F FUSE</p> <p>FA FIRE ALARM CONTROL PANEL</p> <p>GND GROUND</p> <p>GFI GROUND FAULT CIRCUIT INTERRUPTER</p> <p>GI GROUND FAULT INTERRUPTER</p> <p>H HAND HOSE</p> <p>HD HIGH INTENSITY DISCHARGE</p> <p>HD-97 AUTO</p> <p>HPS HIGH PRESSURE SODIUM</p> <p>HVAC HEATING, VENTILATION, &amp; AIR CONDITIONING</p> <p>IG ISOLATED GROUND</p> <p>IPC DAND POWER COMPANY</p> <p>J BOX</p> <p>KA KILOWATT</p> <p>KVA KILO VOLT-AMP</p> <p>KW KILOWATT</p> <p>KWH KILOWATT HOUR</p> <p>LCP LIGHTING CONTROL PANEL</p> <p>MB MAIN BREAKER</p> <p>MBR MAIN CIRCUIT BREAKER</p> <p>MCC MOTOR CONTROL CENTER</p> <p>MCP MAIN DISTRIBUTION PANEL</p> <p>MLO MAIN LUGS ONLY</p> <p>MNC MODULAR METERING CENTER</p> <p>MT METAL HALIDE</p> <p>MSB MAIN SWITCH BOARD</p> <p>MTG MOUNTING</p> <p>N NEUTRAL</p> <p>(N) NEW</p> <p>NC NORMALLY CLOSED</p> <p>NEC NATIONAL ELECTRICAL CODE</p> <p>NC NOT IN CONTRACT</p> <p>NL NIGHT LIGHT</p> <p>NO NORMALLY OPEN</p> <p>NTS NOT TO SCALE</p> <p>OH OVERHEAD</p> <p>OS OCCUPANCY SENSOR</p> <p>P POLES</p> <p>PC PHOTO-CONTROL</p> <p>PVC POLYVINYL CHLORIDE</p> <p>PWR POWER</p> <p>RE REFERENCE</p> <p>REC RECEPTACLE</p> <p>REL RELOCATED</p> <p>SF SQUARE FEET</p> <p>TBD TO BE DETERMINED</p> <p>TDR TIME DELAY RELAY</p> <p>TR TOE BOX</p> <p>TSP TWISTED SHIELDED PAIR</p> <p>TRT TRIPLE TUBE</p> <p>TTB TELEPHONE TERMINAL BOARD</p> <p>(TYP) TYPICAL</p> <p>UC UNDERCABINET</p> <p>UG UNDERGROUND</p> <p>UNO UNLESS NOTED OTHERWISE</p> <p>V VOLT</p> <p>VA VOLT-AMPERE</p> <p>W WATT</p> <p>WG WIRE GUARD</p> <p>WP WEATHER PROOF/NEMA 3R</p> <p>PROVIDE AND INSTALL / PROVIDED AND PROVIDED BY / PROVIDE AND INSTALL</p> <p>NOTE: THIS IS A STANDARD LIST OF COMMONLY USED ELECTRICAL ABBREVIATIONS. SOME OF THE ABBREVIATIONS SHOWN ABOVE MAY NOT BE USED IN THIS DRAWING PACKAGE.</p>	


ELECTRICAL GENERAL NOTES	
<p>A. THESE ELECTRICAL DRAWINGS ARE DIAGRAMMATIC IN NATURE. THEREFORE, THE ELECTRICAL CONTRACTOR SHALL COORDINATE ALL ELECTRICAL EQUIPMENT AND DEVICE LOCATIONS WITH ARCHITECTURAL, MECHANICAL, AND PLUMBING DIVISIONS PRIOR TO BEGINNING WORK. REFER TO AND COORDINATE WITH ARCHITECTURAL, MECHANICAL, AND PLUMBING DRAWINGS FOR ADDITIONAL WORK THAT IS REQUIRED BY THE ELECTRICAL CONTRACTOR.</p> <p>B. ALL CONDUIT AND JUNCTION BOXES ARE TO BE CONCEALED UNLESS LOCATED WITHIN DEDICATED ELECTRICAL OR MECHANICAL ROOMS. USE OF SURFACE MOUNTED RACEWAYS IN ALL OTHER SPACES MUST BE APPROVED BY THE ARCHITECT FOR EACH LOCATION. WHERE SURFACE RACEWAYS ARE APPROVED, UTILIZE WIREMOLD, OR APPROVED EQUAL, SURFACE MOUNTED RACEWAYS PAINTED TO MATCH SURROUNDING WALLS.</p> <p>C. REFER TO ARCHITECTURAL ELEVATIONS FOR OUTLET HEIGHTS WHERE THE SPECIFIC OUTLET HEIGHT IS NOT INDICATED. REFER TO THE ELECTRICAL LEGEND FOR THE DEFAULT OUTLET HEIGHT WHEN NOT INDICATED ON ELEVATIONS OR ON AT THE DEVICES.</p> <p>D. PROVIDE PULL LINE IN ALL EMPTY CONDUITS.</p> <p>E. TERMINATE ALL LOW-VOLTAGE CONDUITS WITH INSULATED THROAT BUSHING.</p> <p>F. MECHANICAL EQUIPMENT INDICATED IS SHOWN IN AN APPROXIMATE LOCATION. COORDINATE EXACT LOCATION WITH MECHANICAL CONTRACTOR PRIOR TO ROUGH-IN.</p> <p>G. ALL NON-LOCKING, 120V, 15 AND 20 AMP RECEPTACLES SHALL BE LISTED TAMPER-RESISTANT RECEPTACLES PER NEC 406.12.</p> <p>H. FIRE ALARM</p> <p>1. INSTALL PLENUM RATED FIRE ALARM CONDUCTORS FROM ALL FIRE ALARM DEVICES INDICATED TO THE FIRE ALARM CONTROL PANEL OR NAC EXTENDER PANELS AS REQUIRED. STUB 3/4" CONDUIT FROM DEVICE TO VOID ABOVE CEILING. PROVIDE MAX EXTENDED PANEL'S QUANTITY AS REQUIRED IN LOCATIONS INDICATED AND CIRCUITING AS REQUIRED FOR A COMPLETE INSTALLATION. CIRCUIT THE FIRE ALARM NOTIFICATION AND NOTIFICATION DEVICES PER THE ELECTRICAL SPECIFICATIONS. FURNISH AND INSTALL ALL APPURTENANCES AND PROGRAMMING REQUIRED FOR A COMPLETE AND OPERATIONAL SYSTEM. REFER TO ELECTRICAL FIRE ALARM SPECIFICATIONS FOR SYSTEM REQUIREMENTS AND SUBMITTAL PROCEDURES.</p> <p>SITE:</p> <p>I. CONTRACTOR SHALL COORDINATE WITH AN UNDERGROUND LOCATING SERVICE PRIOR TO COMMENCING WORK. SEE CIVIL DRAWINGS FOR ADDITIONAL SITE INFORMATION. COORDINATE WITH OTHER SITE DISCIPLINES.</p> <p>J. SITE LIGHTING AND UTILITY EQUIPMENT SHOWN IN APPROXIMATE LOCATION. COORDINATE EXACT LOCATION WITH CIVIL DRAWINGS, PROPERTY LINES, AND UTILITY COMPANIES PRIOR TO ROUGH-IN.</p> <p>K. REFER TO POLE BASE DETAIL FOR SITE LIGHTING POLE BASE REQUIREMENTS.</p> <p>L. ROUTE CONDUITS IN COMMON TRENCH WHERE POSSIBLE REFER TO TRENCHING DETAIL.</p> <p>DEMOL:</p> <p>M. THE ELECTRICAL DEMOLITION DRAWING(S) PROVIDED ARE INTENDED TO ASSIST THE ELECTRICAL CONTRACTOR IN ESTABLISHING AREAS REQUIRING DISCONNECTION, REMOVAL, OR RELOCATION OF ELECTRICAL EQUIPMENT, OUTLETS, WIRING, DEVICES, FIXTURES, ETC. AND MAY NOT INDICATE ALL DEVICES OR THE FULL EXTENT OF DEMOLITION AND RECONNECTION WHICH MAY BE REQUIRED. THE ELECTRICAL CONTRACTOR SHALL VISIT THE JOB SITE AND THOROUGHLY EXAMINE ALL REQUIRED DEMOLITION WORK AND INCLUDE ALL LABOR AND INCIDENTALS THAT WILL BE NECESSARY TO PERFORM DEMOLITION RECONNECTION AND TEMPORARY POWER CONNECTIONS IN THE BID.</p> <p>N. ALL ELECTRICAL DEVICES AND WALLS INDICATED ON THE ELECTRICAL DEMOLITION DRAWING(S) ARE TO REMAIN UNLESS OTHERWISE NOTED.</p>	

ELECTRICAL SPECIFICATIONS																									
A.	ALL WORK SHALL BE IN ACCORDANCE WITH THE LATEST EDITION OF THE LOCALLY ADOPTED ELECTRICAL CODE, ALL LOCAL CODES, AND TO THE FULL ACCEPTANCE OF THE AUTHORITY HAVING JURISDICTION.																								
B.	OBTAIN ALL PERMITS, COORDINATE, FURNISH, INSTALL, CONNECT AND TEST ALL ELECTRICAL EQUIPMENT REQUIRED FOR ALL THE SYSTEMS INSTALLED UNDER THIS CONTRACT TO INSURE COMPLETE AND FULLY OPERATIONAL SYSTEMS.																								
C.	CONTRACTOR SHALL MAINTAIN A COMPLETE SET OF AS-BUILT DRAWINGS. AS-BUILT SET OF DRAWINGS SHALL BE UPDATED DAILY AND SHALL DOCUMENT THE ACTUAL INSTALLED CONDITION OF THE ENTIRE ELECTRICAL INSTALLATION. AS-BUILT SET OF DRAWINGS SHALL BE AVAILABLE AT ALL TIMES ON THE SITE FOR INSPECTION BY CODE OFFICIALS, OWNER, ARCHITECT, AND ENGINEER.																								
D.	PROTECT ALL EXISTING WORK FROM DAMAGE DURING CONSTRUCTION.																								
E.	DESIGN IS BASED ON BEST AVAILABLE INFORMATION. CONTRACTOR SHALL FIELD VERIFY EXISTING CONDITIONS TO DETERMINE STATUS OF ACTUAL CONDITIONS AS THEY RELATE TO THE SCOPE OF WORK AS SHOWN ON THESE PLANS.																								
F.	COORDINATE ALL ELECTRICAL WORK WITH ALL OTHER TRADES.																								
G.	COORDINATE EXACT LOCATION AND MOUNTING HEIGHTS OF ALL ELECTRICAL EQUIPMENT AND DEVICES WITH THE ARCHITECTURAL ELEVATIONS AND DETAILS PRIOR TO ROUGH-IN.																								
H.	DEMOLITION WORK IS A PART OF THIS PROJECT. SEE DRAWINGS FOR EXISTING ELECTRICAL DEVICES TO BE REMOVED. REMOVE ASSOCIATED BOXES, RACEWAYS AND CONDUCTORS BACK TO SOURCE, AND MAKE SWE.																								
I.	ALL MATERIALS AND EQUIPMENT FURNISHED TO THE PROJECT SHALL BE NEW AND SHALL BEAR THE LISTING LABEL OF A NATIONALLY RECOGNIZED TESTING LAB AS DEFINED BY CSA.																								
J.	ALL ELECTRICAL DEVICES AND TERMINALS SHALL BE RATED 75°C MINIMUM.																								
K.	ALL CONDUCTORS SHALL BE STRANDED COPPER, 600 VOLT RATED. INSULATION TYPE SHALL BE THINWALL, FULL COLOR CODED WITH GAUGE TYPE AND MANUFACTURER MARKED EVERY 24" ALONG. CONDUCTOR COLOR CODE SHALL BE AS FOLLOWS:																								
	<table><tr><th>CONDUIT COLOR</th><th>PHASE</th><th>GROUND</th></tr><tr><td>BLACK</td><td>PHASE A</td><td>GROUND</td></tr><tr><td>BROWN</td><td>PHASE B</td><td>GROUND</td></tr><tr><td>RED</td><td>PHASE C</td><td>GROUND</td></tr><tr><td>ORANGE</td><td>NEUTRAL</td><td>GROUND</td></tr><tr><td>YELLOW</td><td>NEUTRAL</td><td>GROUND</td></tr><tr><td>GRAY</td><td>NEUTRAL</td><td>GROUND</td></tr><tr><td>GREEN</td><td>GROUND</td><td>GROUND</td></tr></table>	CONDUIT COLOR	PHASE	GROUND	BLACK	PHASE A	GROUND	BROWN	PHASE B	GROUND	RED	PHASE C	GROUND	ORANGE	NEUTRAL	GROUND	YELLOW	NEUTRAL	GROUND	GRAY	NEUTRAL	GROUND	GREEN	GROUND	GROUND
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GREEN	GROUND	GROUND																							
L.	MINIMUM SIZE WIRE FOR POWER AND LIGHTING CIRCUITS SHALL BE #12 AWG. ALL POWER AND LIGHTING CONDUCTORS SHALL BE ROUTED IN 3/4" CONDUIT MINIMUM.																								
M.	REFER TO POLE BASE DETAIL FOR SITE LIGHTING POLE BASE REQUIREMENTS.																								
N.	MAKE ALL CONNECTIONS TO EQUIPMENT PER MANUFACTURER'S REQUIREMENTS.																								
O.	ALL ELECTRICAL SWITCHING DEVICES AND PANELS SHALL BE MOUNTED SO AS TO BE ACCESSIBLE AND SHALL BE MOUNTED FLUSH WITH WALLS AND SQUARES.																								
P.	DEVICES AND RACEWAYS PENETRATING FIRE RATED WALLS AND FLOORS SHALL BE SEALED WITH FIRE RESISTIVE MATERIAL, COMPATIBLE WITH THE PENETRATING MATERIAL. IN THE CASE OF THE WALL, SEAMANT SYSTEM SHALL BE A UL APPROVED SYSTEM AND INSTALLED PER MANUFACTURER'S INSTRUCTIONS.																								
Q.	FURNISH AND INSTALL PULL CORDS IN ALL EMPTY CONDUITS.																								
R.	ALL JUNCTION BOX COVERS WITH POWER WIRING SHALL HAVE THE PANEL AND CIRCUIT LABELLED ON THE OUTSIDE SURFACE. ALL LABELS FOR PROBING JUNCTION BOXES IN "FINISHED AREA" SHALL BE LABELLED UTILIZING SELF ADHESIVE, NON REMOVABLE, NON TOXIC, NON FLAMMABLE, PRINTED LABELS FOR JUNCTION BOX COVERS IN CONCEALED LOCATIONS SHALL CONSIST OF THE INFORMATION BEING KEPT IN HANDWRITING ON THE OUTSIDE SURFACE OF THE COVER WITH A PERMANENT TYPE MARKER.																								
S.	CLEARLY LABEL ALL ACCESSIBLE CONDUIT STUDS WITH SYSTEM NAME AND LOCATION (ROOM NUMBER) WHERE THE OTHER END OF THE CONDUIT IS LOCATED. USE LABELING METHOD. THE LABEL SHALL BE LOCATED ON THE CONDUIT IN A POSITION THAT CAN BE EASILY READ.																								
T.	ALL 1 POLE BREAKER CIRCUITS SHALL HAVE AN INDEPENDENT NEUTRAL CONDUCTOR. NO EDITION STYLE SHARED NEUTRAL CONDUCTORS ARE ALLOWED.																								
U.	ALL CONDUCTORS IN ELECTRICAL PANELS, CABINETS AND EQUIPMENT SHALL BE NEATLY TRAPPED AND LACED.																								
V.	THE CONTRACTOR SHALL PROVIDE UPDATED CIRCUIT PANEL DIRECTORIES FOR ALL PANELS. DIRECTORIES SHALL BE TYPED.																								
W.	PROVIDE ELECTRICAL SUBMITTALS FOR EQUIPMENT SHOWN AS REQUIRED BY DRAWING SPECIFICATIONS.																								
X.	ELECTRICAL CONTRACTOR SHALL OBTAIN THE AVAILABLE FULL CURRENT VALUE FROM THE LOCALITY OR THE ONE-LINE DIAGRAM AND LABEL THE MAIN BREAKER WITH THAT VALUE.																								
Y.	SWITCH AND RECEPTACLE LABELING: IDENTIFY PANELBOARD AND CIRCUIT NUMBER FROM WHICH DEVICES ARE SERVED. USE THE PRINTED LABEL AND "10" TEXT, INSTALL ON THE OUTSIDE OF THE FACEPLATE FOR RECEPTACLES AND INSIDE THE FACEPLATE FOR SWITCHES.																								

**TOWN OF JACKSON**  
APPROVED FOR BUILDING CONSTRUCTION. ANY DEVIATIONS FROM APPROVED PLANS ARE SUBJECT TO PRIOR APPROVAL. APPROVAL OF THESE PLANS DOES NOT RELIEVE THE DESIGN PROFESSIONAL OF GENERAL CONTRACTOR RESPONSIBILITY FOR THE RESPONSIBILITY OF COMPLIANCE WITH ALL APPLICABLE CODES AND REGULATIONS. ANY AMENDMENTS TO THESE PLANS IS TO BE MADE BY THE DESIGN PROFESSIONAL. ANY INSPECTIONS OF THESE PLANS ARE NOT AVAILABLE ON SITE. ANY INSPECTION MAY BE CANCELLED AND A REINSPECTION CHARGE LEVIED PRIOR TO THE INSPECTION BEING PERFORMED.  
185 E. Hansen Ave, PO Box 4027  
T 208-201-5324  
www.nwks.com

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ISSUED DATE	ISSUED FOR

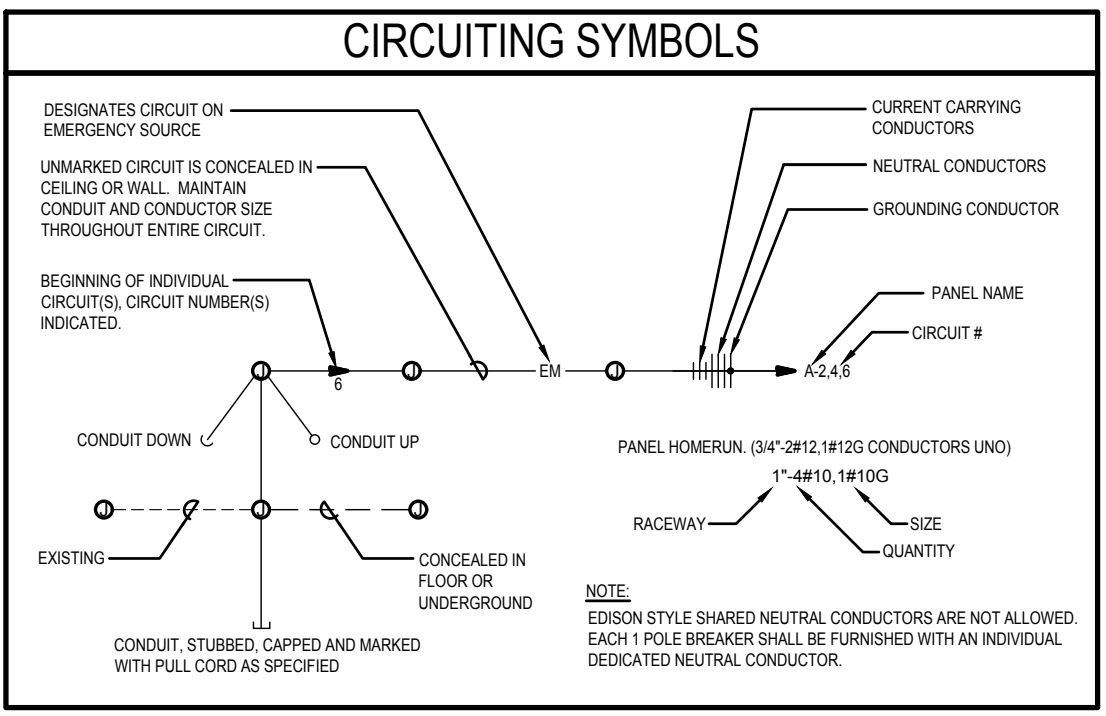

SECURITY	
<p>CCTV CAMERA POWER SUPPLY</p> <p>CCTV SYSTEM POWER SUPPLY</p> <p>ADJUSTABLE CAMERA (PANTILT/ZOOM)</p> <p>FIXED CAMERA</p> <p>CAMERA IN OUTDOOR HOUSING</p> <p>ADJUSTABLE CAMERA (PANTILT/ZOOM) IN OUTDOOR HOUSING</p> <p>CCTV OUTLET, 118" UNO</p> <p>CEILING MOUNTED CCTV OUTLET</p> <p>SECURITY SYSTEM KEYPAD CONTROLLER COORDINATE BOX SIZE AND MOUNTING WITH VENDOR</p> <p>CARD READER</p> <p>CEILING MOUNTED MOTION SENSOR</p> <p>WALL MOUNTED MOTION SENSOR, MOUNTING HEIGHT INDICATED</p> <p>PANIC BUTTON - MOUNTED UNDER COUNTER</p>	

NOTE: THIS IS A STANDARD LIST OF COMMONLY USED ELECTRICAL SYMBOLS. SOME OF THE SYMBOLS SHOWN MAY NOT HAVE BEEN USED IN THIS DRAWING PACKAGE.

Project  
GRACE SPA

22385 Project No.

CJ Drawn By


MNB Checked By

Discipline Drawing No.

**E 0.00**

Drawing Name  
ELECTRICAL COVER SHEET



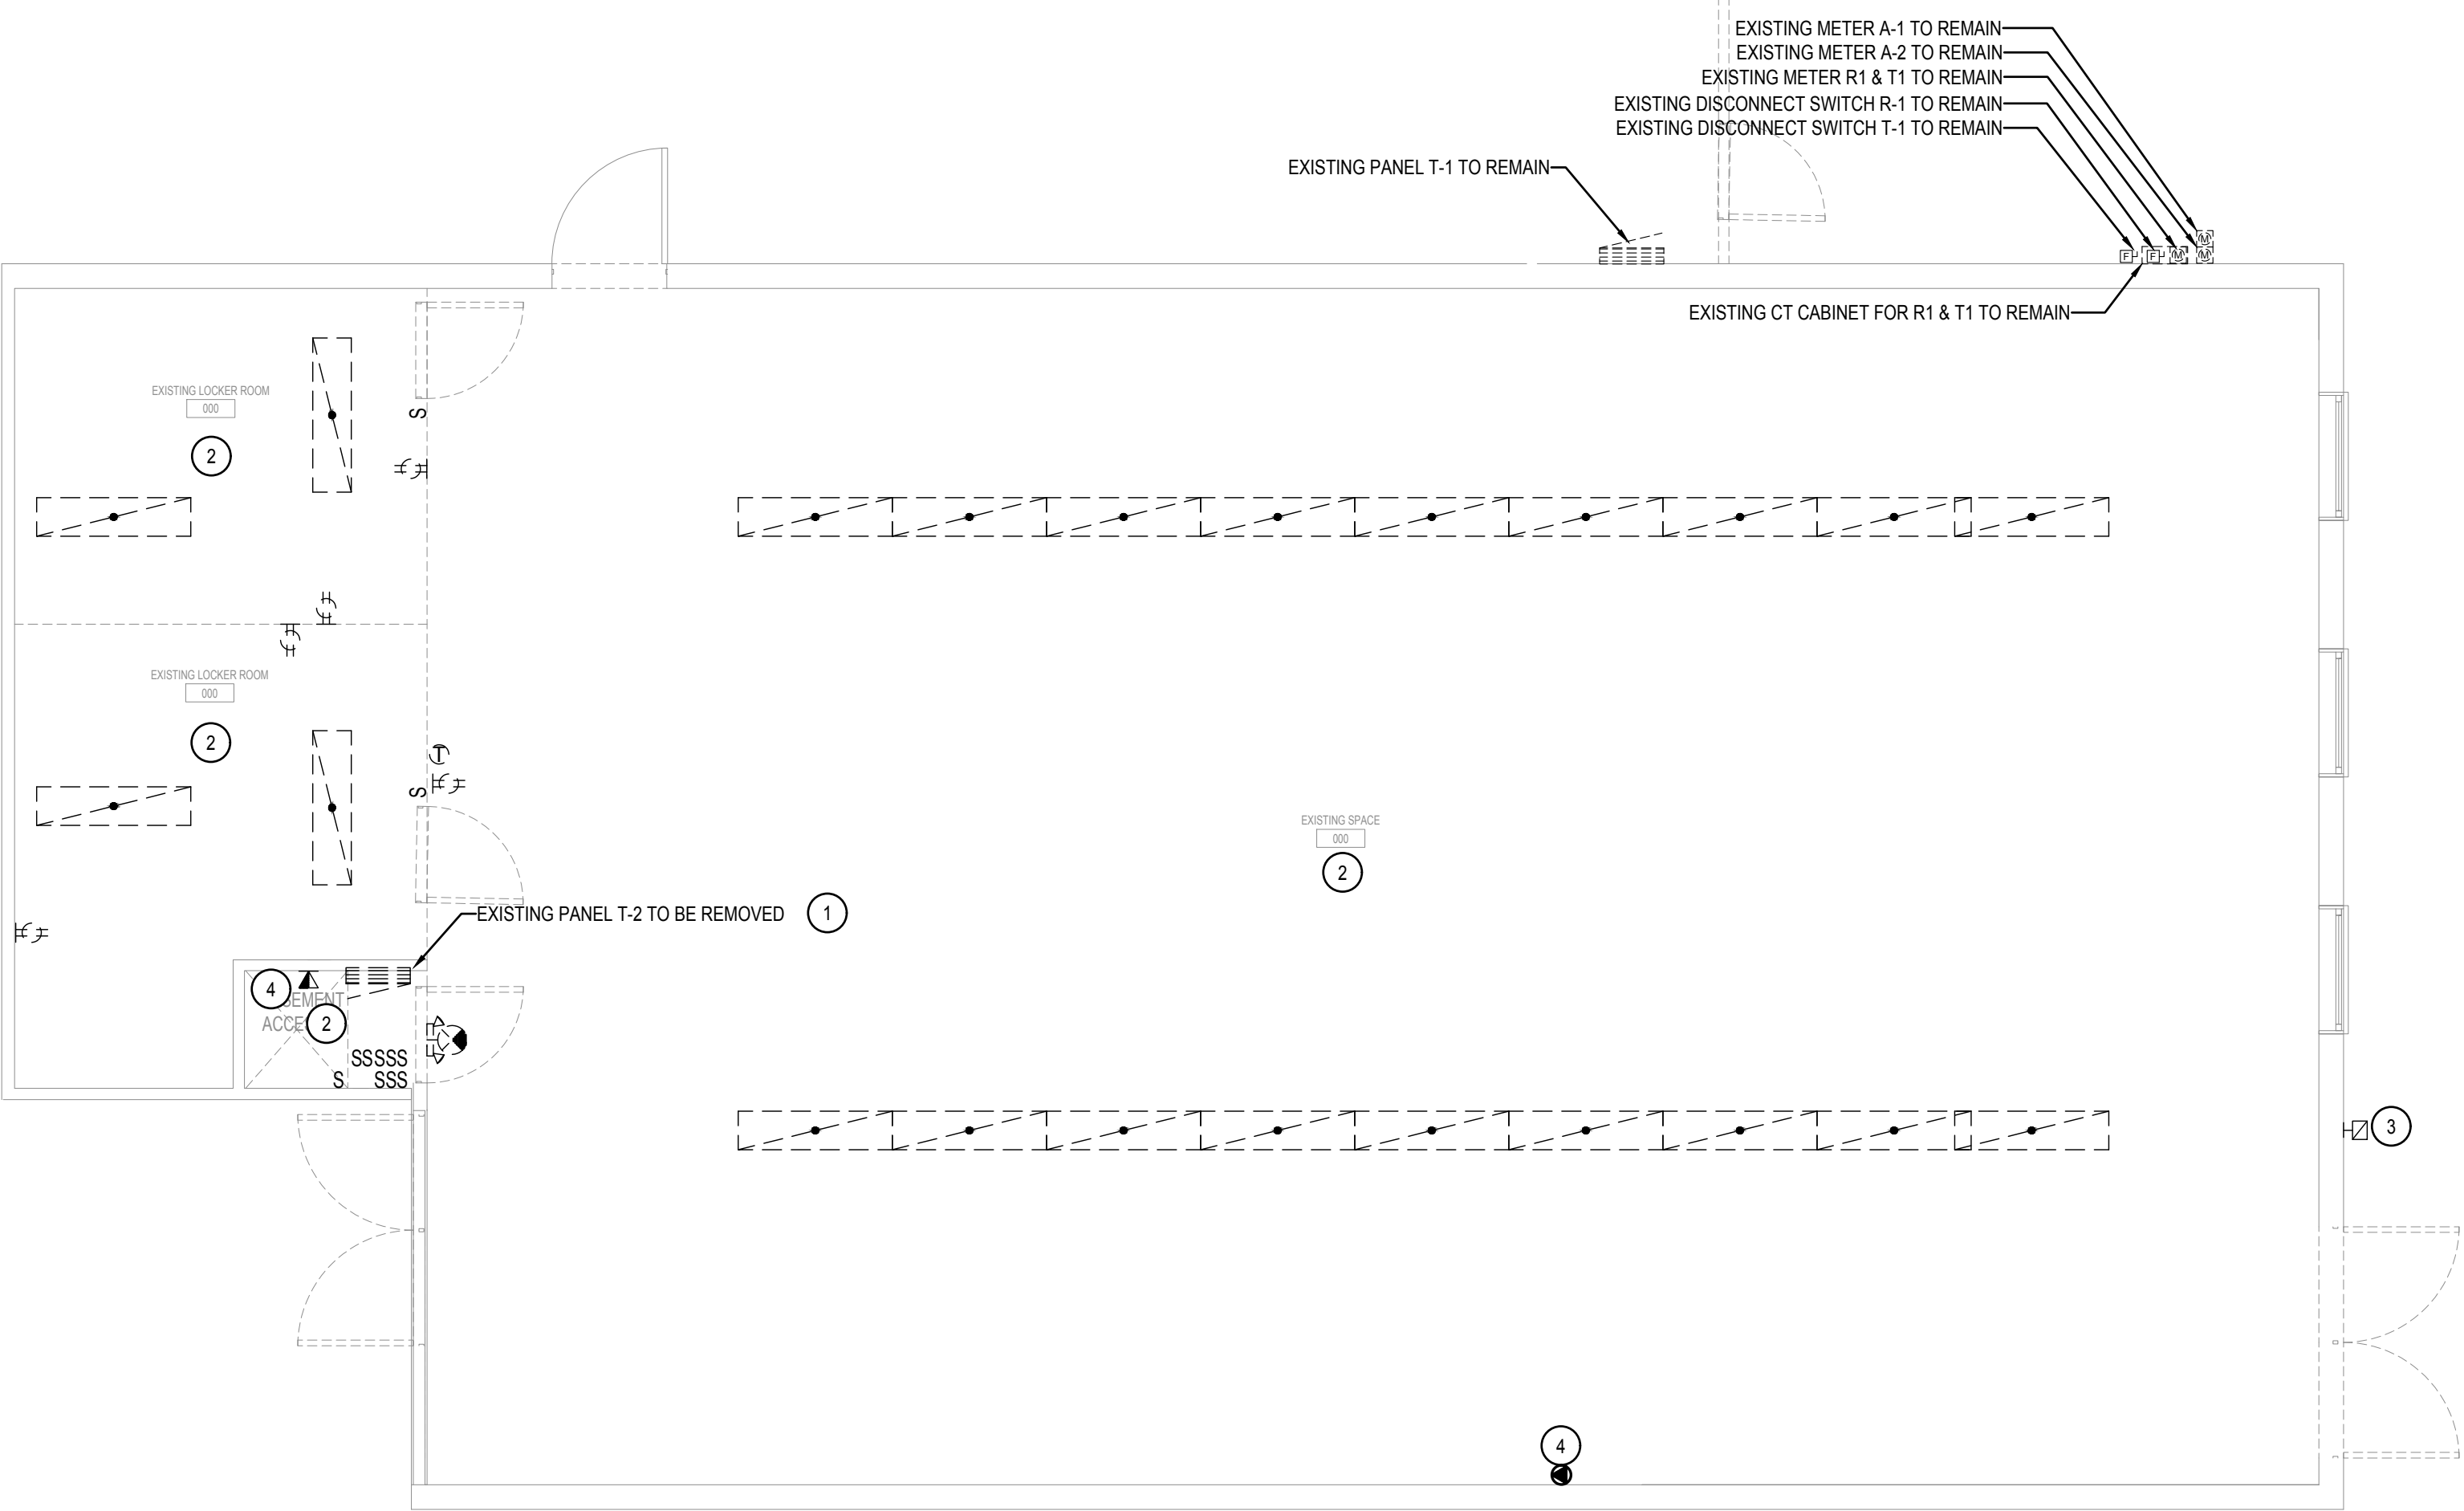

 **1** ELECTRICAL DEMOLITION PLAN  
SCALE: 1/8" = 1'-0"




TOWN OF JACKSON  
APPROVED FOR BUILDING CONSTRUCTION. ANY DEVIATIONS FROM APPROVED PLANS  
ARE SUBJECT TO PRIOR APPROVAL. APPROVAL OF THESE PLANS DOES NOT RELIEVE  
THE DESIGN PROFESSIONAL, GENERAL CONTRACTOR, OR SUBCONTRACTOR OF  
RESPONSIBILITY FOR COMPLIANCE WITH ALL APPLICABLE CODES AND ORDINANCES.  
AN APPROVED SET OF PLANS IS TO BE KEPT ON THE JOB SITE AT ALL TIMES AND  
BY INSPECTORS IF SUCH PLANS ARE NOT AVAILABLE ON SITE, ANY INSPECTION MAY  
BE CANCELLED AND A REINSPECTION CHARGE LEVIED PRIOR TO THE INSPECTION  
BEING PERFORMED.  
PERMIT NO. 10-22-227500  
DATE: 10-10-22  
BUILDING OFFICE  
185 E. Hansen Ave, PO Box 4027 Jackson, WY 83001  
T 208-201-5324 www.mwks.com  
Project No. 22-385

**KEYED NOTES:**

- # SYMBOL USED FOR NOTE CALLOUT.
- EXISTING PANEL TO BE REMOVED, DISCONNECT ALL HOUSE CIRCUITS TO BE MOVED TO NEW HOUSE PANEL. SEE E2.00 AND E4.00 FOR MORE INFORMATION.
  - REMOVE ALL ELECTRICAL DEVICES FROM THIS ROOM.
  - REMOVE EXISTING EXTERIOR LIGHT TO REMAIN.
  - REMOVE EXISTING 30 AMP RECEPTACLE, CONDUIT, AND CONDUCTORS BACK TO ELECTRICAL PANEL BOARD.
  - TELEPHONE RISER CABLE AND 66 BLOCK TO REMAIN.

ISSUED DATE	ISSUED FOR

PROFESSIONAL SEAL

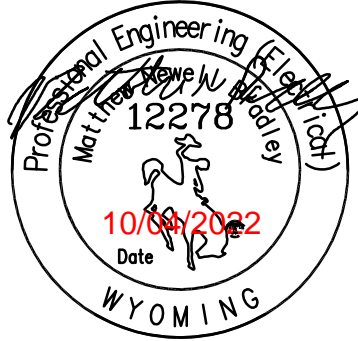

Project  
GRACE SPA

22385	Project No.
CJ	Drawn By
MNB	Checked By

Discipline	Drawing No.
ED	1.00

Drawing Name  
ELECTRICAL DEMOLITION PLAN





COMcheck Software Version 4.1.5.3  
Interior Lighting Compliance Certificate

Project Information

Energy Code: 2012 IECC  
Project Title: GRACE SPA  
Project Type: New Construction

Construction Site: JACKSON, WY  
Owner/Agent: GRACE SPA  
JACKSON, WY  
Designer/Contractor: MATTHEW BRADLEY  
MUSGROVE ENGINEERING  
645 W 25TH ST  
IDAHO FALLS, ID 83402  
208-523-2862  
MATTB@MUSGROVEPA.COM

Credits: 1.0 Required 1.0 Proposed  
Reduced Lighting Power: 1.0 credit

Allowed Interior Lighting Power

A Area Category	B Floor Area (ft <sup>2</sup> )	C Allowed Watts / ft <sup>2</sup>	D Allowed Watts (B X C)
1-Retail	1754	1.30	2280
		Total Allowed Watts =	2280

Proposed Interior Lighting Power

A Fixture ID : Description / Lamp / Wattage Per Lamp / Ballast	B Lamps/ Fixture	C # of Fixtures	D Fixture Watt.	E (C X D)
1-Retail				
LED 1: A: LED A Lamp 12W.	1	48	10	480
LED 2: P1: LED Other Fixture Unit 25W	1	3	16	48
LED 3: P2: LED Other Fixture Unit 36W	1	2	11	22
LED 4: P3: LED Other Fixture Unit 16W	1	4	17	68
LED 5: S1: LED Other Fixture Unit 13W	1	6	16	96
		Total Proposed Watts =	714	

Interior Lighting PASSES: Design 69% better than code

Interior Lighting Compliance Statement

Compliance Statement: The proposed interior lighting design represented in this document is consistent with the building plans, specifications, and other calculations submitted with this permit application. The proposed interior lighting systems have been designed to meet the 2012 IECC requirements in COMcheck Version 4.1.5.3 and to comply with any applicable mandatory requirements listed in the Inspection Checklist.

MATTHEW BRADLEY, P.E.  
Name - Title  
Signature  
10-3-22  
Date

Project Title: GRACE SPA  
Data filename: P:\Files\2022\22385\CALCS\ELEC\22385 Electrical\_Compliance.cck  
Report date: 10/03/22  
Page 1 of 7

Section # & Req.ID	Rough-In Electrical Inspection	Complies?	Comments/Assumptions
C405.2.2 [EL22] <sup>1</sup>	Automatic controls to shut off all building lighting installed in all buildings.	<input type="checkbox"/> Complies <input type="checkbox"/> Does Not <input type="checkbox"/> Not Observable <input type="checkbox"/> Not Applicable	
C405.2.1.1 [EL23] <sup>1</sup>	Independent lighting controls installed per approved lighting plans and all manual controls readily accessible and visible to occupants.	<input type="checkbox"/> Complies <input type="checkbox"/> Does Not <input type="checkbox"/> Not Observable <input type="checkbox"/> Not Applicable	
C405.2.1.2 [EL15] <sup>1</sup>	Lighting controls installed to uniformly reduce the lighting load by at least 50%.	<input type="checkbox"/> Complies <input type="checkbox"/> Does Not <input type="checkbox"/> Not Observable <input type="checkbox"/> Not Applicable	
C405.2.2.3 [EL16] <sup>1</sup>	Daylight zones provided with individual controls that control the lights independent of general area lighting.	<input type="checkbox"/> Complies <input type="checkbox"/> Does Not <input type="checkbox"/> Not Observable <input type="checkbox"/> Not Applicable	
C405.2.3 [EL17] <sup>1</sup>	Sleeping units have at least one master switch at the main entry door that controls wired luminaires and switched receptacles.	<input type="checkbox"/> Complies <input type="checkbox"/> Does Not <input type="checkbox"/> Not Observable <input type="checkbox"/> Not Applicable	
C405.2.2.2 [EL18] <sup>1</sup>	Occupancy sensors installed in required spaces.	<input type="checkbox"/> Complies <input type="checkbox"/> Does Not <input type="checkbox"/> Not Observable <input type="checkbox"/> Not Applicable	
C405.2.2.3 [EL20] <sup>1</sup>	Primary sidelighted areas are equipped with required lighting controls.	<input type="checkbox"/> Complies <input type="checkbox"/> Does Not <input type="checkbox"/> Not Observable <input type="checkbox"/> Not Applicable	
C405.2.2.2 [EL21] <sup>1</sup>	Enclosed spaces with daylight area under skylights and rooftop monitors are equipped with required lighting controls.	<input type="checkbox"/> Complies <input type="checkbox"/> Does Not <input type="checkbox"/> Not Observable <input type="checkbox"/> Not Applicable	
C405.2.4 [EL25] <sup>1</sup>	Automatic lighting controls for exterior lighting installed.	<input type="checkbox"/> Complies <input type="checkbox"/> Does Not <input type="checkbox"/> Not Observable <input type="checkbox"/> Not Applicable	
C405.2.3 [EL4] <sup>1</sup>	Separate lighting control devices for specific uses installed per approved lighting plans.	<input type="checkbox"/> Complies <input type="checkbox"/> Does Not <input type="checkbox"/> Not Observable <input type="checkbox"/> Not Applicable	
C405.3 [EL19] <sup>1</sup>	Fluorescent luminaires with odd numbered lamp configurations that are within 10 feet center to center (if recess mounted) or are within 1 foot edge to edge (if pendant or surface mounted) shall be tandem wired.	<input type="checkbox"/> Complies <input type="checkbox"/> Does Not <input type="checkbox"/> Not Observable <input type="checkbox"/> Not Applicable	
C405.4 [EL6] <sup>1</sup>	Exit signs do not exceed 5 watts per face.	<input type="checkbox"/> Complies <input type="checkbox"/> Does Not <input type="checkbox"/> Not Observable <input type="checkbox"/> Not Applicable	

1 High Impact (Tier 1) 2 Medium Impact (Tier 2) 3 Low Impact (Tier 3)  
Project Title: GRACE SPA  
Data filename: P:\Files\2022\22385\CALCS\ELEC\22385 Electrical\_Compliance.cck  
Report date: 10/03/22  
Page 4 of 7



COMcheck Software Version 4.1.5.3  
Exterior Lighting Compliance Certificate

Project Information

Energy Code: 2012 IECC  
Project Title: GRACE SPA  
Project Type: New Construction  
Exterior Lighting Zone: 2 (Residential mixed use area (LZ2))

Construction Site: JACKSON, WY  
Owner/Agent: GRACE SPA  
JACKSON, WY  
Designer/Contractor: MATTHEW BRADLEY  
MUSGROVE ENGINEERING  
645 W 25TH ST  
IDAHO FALLS, ID 83402  
208-523-2862  
MATTB@MUSGROVEPA.COM

Allowed Exterior Lighting Power

A Area/Surface Category	B Quantity	C Allowed Watts / Unit	D Tradable Wattage	E Allowed Watts (B X C)
Main entry	6 ft of door	20	Yes	120
		Total Tradable Watts (a) =	120	
		Total Allowed Watts =	120	
		Total Allowed Supplemental Watts (b) =	600	

(a) Wattage tradeoffs are only allowed between tradable areas/surfaces.  
(b) A supplemental allowance equal to 600 watts may be applied toward compliance of both non-tradable and tradable areas/surfaces.

Proposed Exterior Lighting Power

A Fixture ID : Description / Lamp / Wattage Per Lamp / Ballast	B Lamps/ Fixture	C # of Fixtures	D Fixture Watt.	E (C X D)
Main entry (6 ft of door width): Tradable Wattage				
LED 1: F: LED A Lamp 2.9W.	1	1	1	1
		Total Tradable Proposed Watts =	1	

Exterior Lighting PASSES: Design 100% better than code

Exterior Lighting Compliance Statement

Compliance Statement: The proposed exterior lighting design represented in this document is consistent with the building plans, specifications, and other calculations submitted with this permit application. The proposed exterior lighting systems have been designed to meet the 2012 IECC requirements in COMcheck Version 4.1.5.3 and to comply with any applicable mandatory requirements listed in the Inspection Checklist.

MATTHEW BRADLEY, P.E.  
Name - Title  
Signature  
10-3-22  
Date

Project Title: GRACE SPA  
Data filename: P:\Files\2022\22385\CALCS\ELEC\22385 Electrical\_Compliance.cck  
Report date: 10/03/22  
Page 2 of 7

Section # & Req.ID	Rough-In Electrical Inspection	Complies?	Comments/Assumptions
C405.6 [EL24] <sup>1</sup>	Exterior grounds lighting over 100 W provides >60 lm/W unless on motion sensor or fixture is exempt from scope of code or from external LPD.	<input type="checkbox"/> Complies <input type="checkbox"/> Does Not <input type="checkbox"/> Not Observable <input type="checkbox"/> Not Applicable	
C405.2.3 [EL8] <sup>1</sup>	Additional interior lighting power allowed for special functions per the approved lighting plans and is automatically controlled and separated from general lighting.	<input type="checkbox"/> Complies <input type="checkbox"/> Does Not <input type="checkbox"/> Not Observable <input type="checkbox"/> Not Applicable	

Additional Comments/Assumptions:

1 High Impact (Tier 1) 2 Medium Impact (Tier 2) 3 Low Impact (Tier 3)  
Project Title: GRACE SPA  
Data filename: P:\Files\2022\22385\CALCS\ELEC\22385 Electrical\_Compliance.cck  
Report date: 10/03/22  
Page 5 of 7



COMcheck Software Version 4.1.5.3  
Inspection Checklist

Energy Code: 2012 IECC

Requirements: 0.0% were addressed directly in the COMcheck software

Text in the "Comments/Assumptions" column is provided by the user in the COMcheck Requirements screen. For each requirement, the user certifies that a code requirement will be met and how that is documented, or that an exception is being claimed. Where compliance is itemized in a separate table, a reference to that table is provided.

Section # & Req.ID	Plan Review	Complies?	Comments/Assumptions
C103.2 [PR4] <sup>1</sup>	Plans, specifications, and/or calculations provide all information with which compliance can be determined for the interior lighting and electrical systems and equipment and document where exceptions to the standard are claimed. Information provided should include interior lighting power calculations, wattage of bulbs and ballasts, transformers and control devices.	<input type="checkbox"/> Complies <input type="checkbox"/> Does Not <input type="checkbox"/> Not Observable <input type="checkbox"/> Not Applicable	
C103.2 [PR8] <sup>1</sup>	Plans, specifications, and/or calculations provide all information with which compliance can be determined for the exterior lighting and electrical systems and equipment and document where exceptions to the standard are claimed. Information provided should include exterior lighting power calculations, wattage of bulbs and ballasts, transformers and control devices.	<input type="checkbox"/> Complies <input type="checkbox"/> Does Not <input type="checkbox"/> Not Observable <input type="checkbox"/> Not Applicable	
C406 [PR9] <sup>1</sup>	Plans, specifications, and/or calculations provide all information with which compliance can be determined for the additional energy efficiency package options.	<input type="checkbox"/> Complies <input type="checkbox"/> Does Not <input type="checkbox"/> Not Observable <input type="checkbox"/> Not Applicable	

Additional Comments/Assumptions:

1 High Impact (Tier 1) 2 Medium Impact (Tier 2) 3 Low Impact (Tier 3)  
Project Title: GRACE SPA  
Data filename: P:\Files\2022\22385\CALCS\ELEC\22385 Electrical\_Compliance.cck  
Report date: 10/03/22  
Page 3 of 7

TOWN OF JACKSON  
APPROVED FOR BUILDING CONSTRUCTION. ANY DEVIATIONS FROM APPROVED PLANS ARE SUBJECT TO PRIOR APPROVAL. APPROVAL OF THESE PLANS DOES NOT RELIEVE THE DESIGN PROFESSIONAL, GENERAL CONTRACTOR, OR SUBCONTRACTOR OF THEIR RESPONSIBILITIES TO COMPLY WITH ALL APPLICABLE CODES, ORDINANCES, AND REGULATIONS. AN APPEAL OF THESE PLANS IS TO BE FILED WITH THE TOWN ENGINEER OF JACKSON. ANY INSPECTIONS OF THESE PLANS ARE NOT AVAILABLE ON SITE. ANY INSPECTION MAY BE CANCELLED AND A REINSPECTION CHARGE LEVIED PRIOR TO THE INSPECTION BEING PERFORMED.  
PERMIT NO. 10-10-22-000000  
DATE: 10-10-22  
PROJECT NO. 22-385  
185 E. Hansen Ave, PO Box 4027 Jackson, WY 83001  
T 208-201-5324 www.nwks.com

ISSUED DATE	ISSUED FOR

PROFESSIONAL SEAL

Professional Engineering Seal  
Matthew Bradley  
12278  
10/03/22  
WYOMING

Project  
GRACE SPA


22385	Project No.
CJ	Drawn By
MNB	Checked By
Discipline	Drawing No.

E 0.01

Drawing Name

LIGHTING COMPLIANCE







THE D  
RESP  
AN APP  
BY INS  
BE CAN  
BEING  
PERMI  
DATE:  
BUILD

① SYMBOL USED FOR NOTE CALLOUT.

- © 2019 Northworks Architects & Planners - All rights reserved. Any discrepancies shall be reported immediately to the Architect before proceeding. Only figured dimensions should be used. Contractors and fabricators to verify all dimensions on site prior to beginning Work.

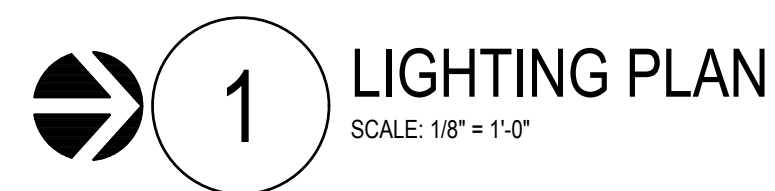[illegible]

PROFESSIONAL SEAL

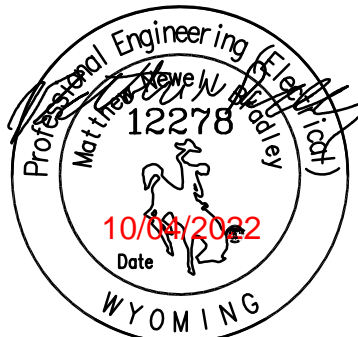Project  
GRACE SPA

22385	Project No.
CJ	Drawn By
MNB	Checked By
Discipline	Drawing No.


E	1.00
Drawing Name	
LIGHTING PLAN	




THE D  
RESP  
AN APP  
BY INS  
BE CAN  
BEING  
PERMI  
DATE:  
BUILD

① SYMBOL USED FOR NOTE CALLOUT.

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[illegible]

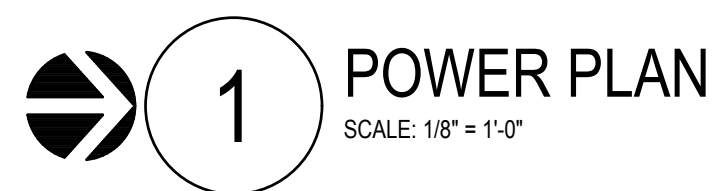PROFESSIONAL SEAL

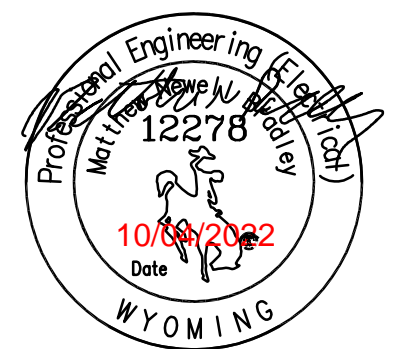

22385	Project No.
CJ	Drawn By
MNB	Checked By
Discipline	Drawing No.


Drawing Name \_\_\_\_\_


## POWER PLAN



KEYED NOTES:


- # SYMBOL USED FOR NOTE CALLOUT.
- KING COVE HEATER MODEL #KCV2006-W OR EQUAL.
  - SEE SHEET E5.0 FOR THERMOSTAT ROUGH-IN ELEVATION DETAIL.

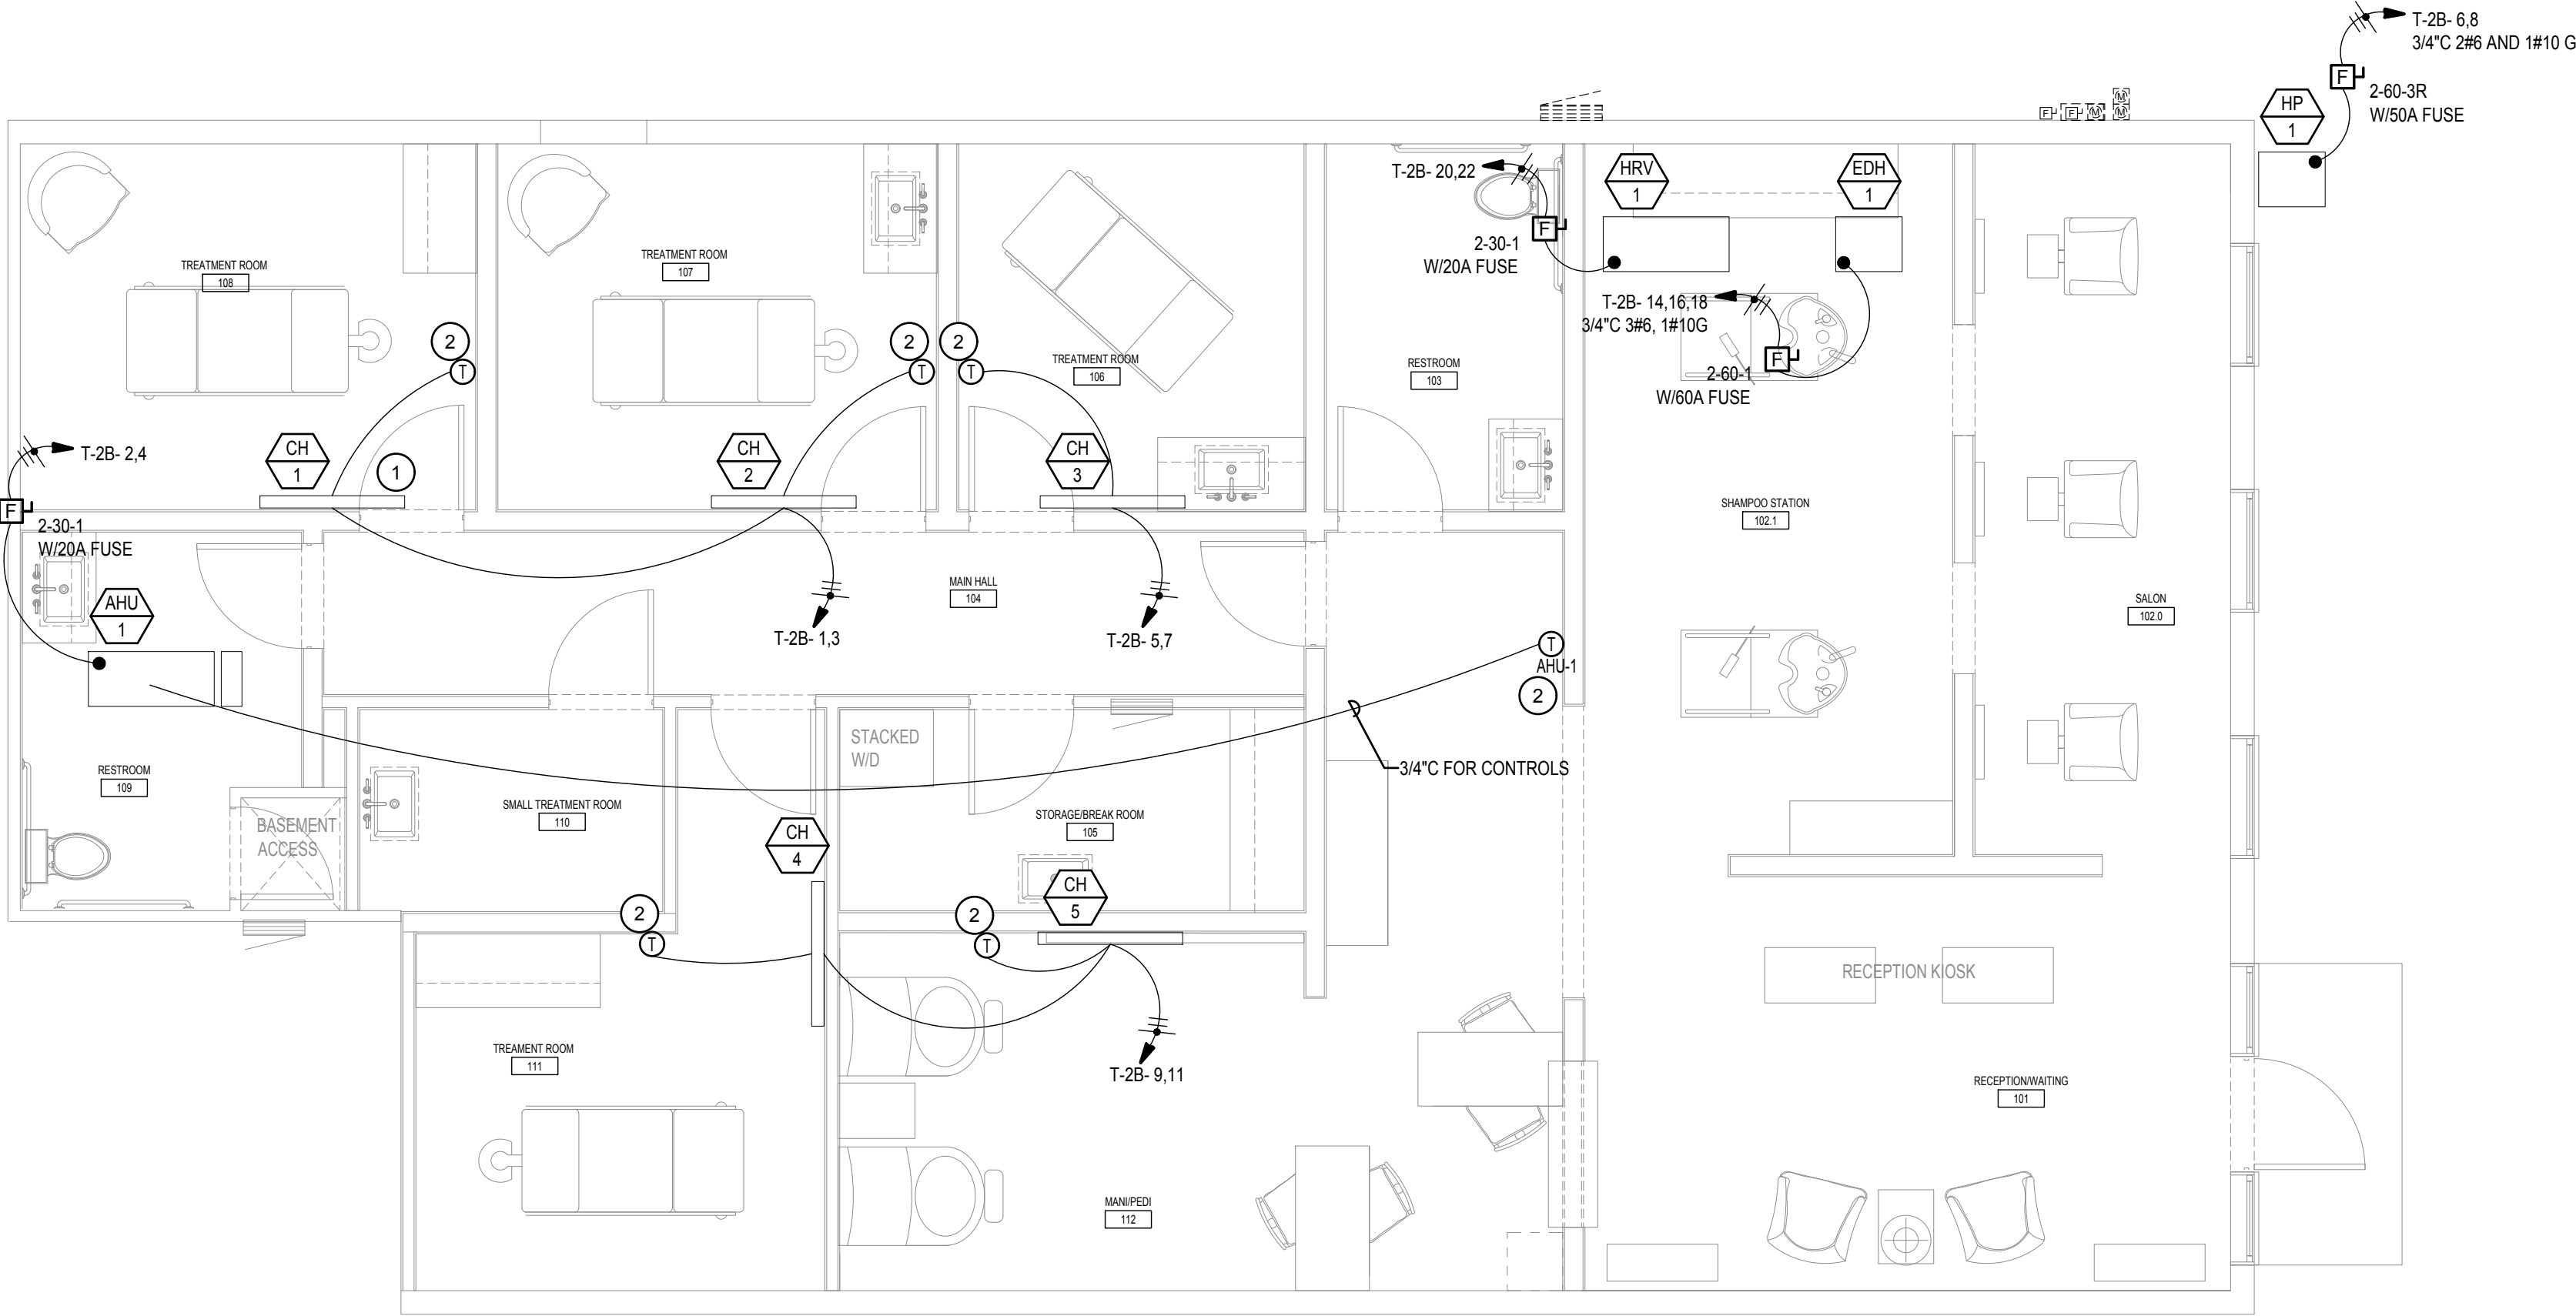

 1 MECHANICAL POWER PLAN  
SCALE: 1/8" = 1'-0"

ISSUED DATE	ISSUED FOR

PROFESSIONAL SEAL

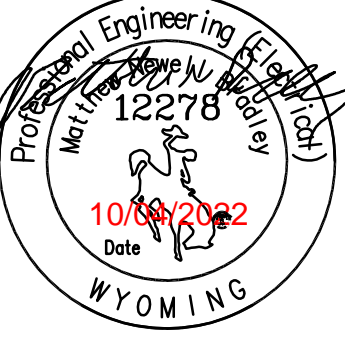

Project  
GRACE SPA

22385	Project No.
CJ	Drawn By
MNB	Checked By

Discipline

E


Drawing No.

2.01

Drawing Name  
MECHANICAL POWER PLAN

THE DESIGN PROFESSIONAL'S  
RESPONSIBILITY FOR COMPLIANCE  
APPROVED FOR THE  
BY INSPECTOR(S) OF SUCH LAND  
AS CANCELLED AND A REINSPECTION  
BEING PERFORMED  
PERMIT NO. 822-0060  
ISSUED FOR THE 83402  
DATE: 10-10-22 08 523 2862  
BUILDING OFFICIAL: KS  
www.madgovepa.com  
Project No. 22-385

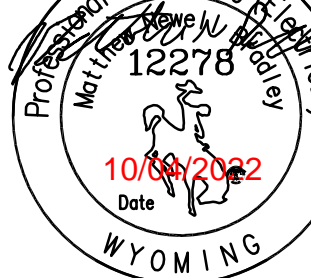

PROFESSIONAL SEAL	
	
<p>Project <b>GRACE SPA</b></p>	
22385	Project No.
CJ	Drawn By
MNB	Checked By
Discipline	Drawing No.
<b>E</b>	<b>3.00</b>
<p><u>Drawing Name</u></p>	
<p><b>SINGLE LINE DIAGRAM</b></p>	



PANEL: (E)-R1						PROJECT: GRACESPA								
VOLTAGE		240 / 120 V		3 PH		4 WIRE		AMPERE RATING: 400A		WITH 400A CB		MOUNTING: SURFACE		
BASIS OF DESIGN PANEL TYPE:				PANEL BOARD		NEMA ENCLOSURE TYPE: 1		PANEL A/C RATING: 22000						
<b>CKT NOTES:</b> 1. GFCI FOR PERSONNEL PROTECTION (5mA) 2. EXISTING BREAKER 3. INSTALL NEW BREAKER 22K A/C CIRCUIT BREAKER						<b>REMARKS:</b> ELECTRICAL CONTRACTOR TO VERIFY ALL CIRCUITS PRIOR TO WORK  PANEL IS 240/120V 3 PHASE OPEN DELTA - LABEL IN ACCORDANCE WITH NEC 110.15 <b>BUSING MAXIMUM DEMAND FOR PANEL R-1 51.8 KW 9/8/2022 INCLUDED IN THE TOTAL VA CALCULATION</b>								
CKT	DESCRIPTION	CKT NOTE	LOAD VA	LOAD AMPS	AMPS/ POLES	LOAD (VA) B (240)	C	AMPS/ POLES	LOAD AMPS	LOAD VA	LOAD VA	CKT NOTE	DESCRIPTION	CKT
1	ELEVATOR			0.0	100 3	0			90 3	0.0		3	PANEL RT-2	2
3	***			0.0	** *	0			** *	0.0			***	4
7	***			0.0	** *			0	** *	0.0			***	6
7	BLANK					0							BLANK	8
9	HIGH LEG					0							HIGH LEG	10
11	PANEL R2	3		0.0	50 2		0	125 2	0.0				PANEL W	12
13	***			0.0	** *	0			** *	0.0			***	14
15	HIGH LEG					0							HIGH LEG	14
17	PANEL R3	3		0.0	60 2		10255	125 2	85.5	10255.0	3		PANEL T-2A	18
19	***			0.0	** *	9100			** *	75.8	9100.0	3	***	20
21	HIGH LEG			0.0		0							HIGH LEG	22
23	PANEL R4	3		0.0	60 2		0						BLANK	24
25	***			0.0	** *	8686 2		125 3	69.9	8686	3		PANEL T-2B	26
27	HIGH LEG			0.0		11286.2		** *	69.9	11286	3		***	28
29	PANEL R5	3		0.0	50 2		9080	** *	69.9	9080.0	3		***	30
31	***			0.0	** *	0							BLANK	32
33	HIGH LEG			0.0		0							HIGH LEG	34
35	PANEL T-3	3		0.0	100 2		0	60 2			3		PANEL T-2C	36
37	***			0.0	** *	0		** *			3		***	38
39	HIGH LEG			0.0		0							HIGH LEG	40
41	BLANK			0.0			0						BLANK	42
						34986.2	28486.2	36535.0	VA					
						291.6	237.4	304.5	AMPS					
										1E+05 TOTAL VA				

PANEL: (E)-T-1

VOLTAGE: 208 / 120 V

BASIS OF DESIGN PANEL TYPE

CKT NOTES:  
1. GFCI FOR PERSONNEL PROTECTION (5mA)  
2. EXISTING BREAKER

PROJECT: GRACES SPA

1 PH3 WIRE

AMPERE RATING: 200A

NEMA ENCLOSURE TYPE

1

MOUNTING: FLUSH

PANEL AIC RATING: 10000 AIC

REMARKS:  
ELECTRICAL CONTRACTOR TO VERIFY ALL CIRCUITS PRIOR TO WORK

EXISTING MAXIMUM DEMAND FOR PANEL T-1 31.5 KW 8/4/2022 INCLUDED IN THE TOTAL VA CALCULATION

CKT	DESCRIPTION	CKT NOTE	LOAD VA	LOAD AMPS	AMPS/ POLES	A	LOAD (VA)	AMPS/ POLES	LOAD AMPS	LOAD VA	CKT NOTE	DESCRIPTION	CKT	
							NA	C						
1	PANEL T-4	2	0.0	125	6	0		70	3	0.0	2	BOILER	2	
3		2	0.0	**	*	0		0	**	1	0.0	2	***	4
5		2	0.0	**	*	0		0	**	* 0.0	2	***	6	
7		2	0.0	**	*	0		0	20	1	0.0	2	BOILER CRT	8
9		2	0.0	**	*	0						UNUSABLE SPACE	10	
11		2	0.0	**	*	0		0	20	1	0.0	2	BOILER CRT	12
13	RT3	2	0.0	90	3	0		20	3	0.0	2	COMPRESSOR	14	
15		2	0.0	**	*	0		0	**	* 0.0	2	***	16	
17		2	0.0	**	*	0			**	* 0.0	2	***	18	
19	RT1	2	0.0	90	3	0		0	50	3	0.0	2	EMERGENCY PUMP IN BASEMENT	20
21		2	0.0	**	*	0			**	* 0.0	2	***	22	
23		2	0.0	**	*	0		0	**	* 0.0	2	***	24	
25	SPARE	2	0.0	50	2	0		125	2	0.0	2	PANEL T-2 - RELABEL AS SPARE	26	
27		2	0.0	**	*	0		0	**	* 0.0	2	***	28	
29	SPARE	2	0.0	70	2	0		125	1	0.0	2	PANEL T-3	30	
31		2	0.0	**	*	0		0	**	* 0.0	2	***	32	
33	GARAGE RECEPTACLES	2	0.0	20	1	0		0	30	2	0.0	2	DRY ER	34
35	GARAGE RECEPTACLES	2	0.0	20	1	0		0	**	* 0.0	2	***	36	
37	GARAGE RECEPTACLES	2	0.0	20	1	0		0	20	1	0.0	2	HY-DR0 TEST UNIT	38
39	GARAGE LIGHTS	2	0.0	20	1	0		0	20	1	0.0	2	WASHER	40
41	WAP/WAVE	2	0.0	20	1	0		0	20	1	0.0	2	BENCH RECEPTACLES AND HOOD	42
43	FREEZER	2	0.0	50	*	0		0	20	1	0.0	2	GARAGE RECEPTACLES	44
45	WELDER	2	0.0	50	*	0		0	20	1	0.0	2	GARAGE RECEPTACLES	46
47		2	0.0	**	*	0		0	20	1	0.0	2	UNIT HEATER	48
49	UNUSABLE SPACE	0.0	20	1	0			0	20	1	0.0		UNUSABLE SPACE	50
51	UNUSABLE SPACE	0.0	20	1	0			0	20	1	0.0		UNUSABLE SPACE	52
53	UNUSABLE SPACE	0.0	20	1	0			0	20	1	0.0		UNUSABLE SPACE	54
							15750.0	131.3				31500 TOTAL VA		
							15750.0	131.3		VA				
							15750.0	131.3		AMPS				

PANEL: (E)-T-2						PROJECT: GRACE SPA													
VOLTAGE: 240 / 120 V						1 PH		3 WIRE		AMPERE RATING: 225A		WITH 200A CB		MOUNTING: FLUSH					
BASIS OF DESIGN PANEL TYPE:						PANEL BOARD				NEMA ENCLOSURE TYPE: 1				PANEL AIC RATING: 10000 AIC					
CKT NOTES: 1. GFCI FOR PERSONNEL PROTECTION (5mA) 2. EXISTING BREAKER 3. RELOCATE TO NEW PANEL H										REMARKS: ELECTRICAL CONTRACTOR TO VERIFY ALL CIRCUITS PRIOR TO WORK  PANEL REMOVED AND LOADS DISTRIBUTED BETWEEN 2 PANELBOARDS.									
CKT	DESCRIPTION	CKT NOTE	LOAD VA	LOAD AMPS	AMPS/ POLES	A	LOAD (VA) N/A	C	AMPS/ POLES	LOAD AMPS	LOAD VA	CKT NOTE	DESCRIPTION	C					
1	SPARE	2	0.0	20	1	0			15	1	0.0	2	SPARE	0					
3	EAST LOCKER ROOM RECEPIS	2	0.0	20	1			0	20	1	0.0	2	SPARE						
5	WEST LOCKER ROOM RECEPIS	2	0.0	20	1	0			20	1	0.0	2.3	WEST RETAIL AREA RECEPIS						
7	TRAXX LIGHTING 2ND FLOOR	2.3	0.0	20	1			0	20	1	0.0	2.3	RETAIL MAIN LIGHTING/STAIR FAN						
9	TRAXX AND HALL LIGHTS	2.3	0.0	20	1	0			20	1	0.0	2.3	TRAXX LIGHTS RETAIL						
11	LOCKER/PUBLIC PATH/ LOW STAIR LIGHTS	2.3	0.0	20	1			0	20	1	0.0	2.3	TRAXX LIGHTS RETAIL						
13	PUBLIC BATH RECEPIS & HEATER	2.3	0.0	20	1	0			20	1	0.0	2	POOL LIGHTING						
15	EAST RETAIL AREA RECEPIS	2.3	0.0	20	1			0	20	1	0.0	2	POOL LIGHTING						
17	POOL AREA RECEPIS	2	0.0	20	1	0			20	1	0.0	2	SPARE						
19	SPARE	2	0.0	20	1			0	50	2	0.0	2.3	SUB PANEL T-2(A) CHANGE NAME TO T-2(C)	2					
21	LOCKERS EXHAUST FAN	2	0.0	20	1	0			**	*	0.0	2.3	***	2					
23	SPARE	2	0.0	20	1			0	20	1	0.0	2	SPARE	2					
25	SPARE	2	0.0	20	1	0			20	1	0.0	2	SPARE	2					
27	SPARE	2	0.0	20	1			0	20	1	0.0	2	SPARE	2					
29	SPARE	2	0.0	20	1	0			20	1	0.0	2	SPARE	3					
31	SPARE	2	0.0	20	1			0	20	1	0.0	2	SPARE	3					
33	SPARE	2	0.0	20	1	0			20	1	0.0	2	SPARE	3					
35	SPARE	2	0.0	20	1			0	20	1	0.0	2	SPARE	3					
37	SPARE	2	0.0	20	1	0			20	1	0.0	2	SPARE	3					
39	SPARE	2	0.0	20	1			0	20	1	0.0	2	SPARE	4					
41	SPARE	2	0.0	20	1	0			20	1	0.0	2	SPARE	4					
						0.0		0.0	VA										
						0.0		0.0	AMPS	0 TOTAL VA									


NEW PANEL: T-3				PROJECT: GRACE SPA														
VOLTAGE: 240 / 120 V				1	PH	3	WIRE	AMPERE RATING: 125A		WITH	125A	MLO	MOUNTING: FLUSH					
BASIS OF DESIGN PANEL TYPE:				PANEL BOARD				NEMA ENCLOSURE TYPE: 1				PANEL AIC RATING: 10000 AIC						
CKT NOTES: 1. GFCI FOR PERSONNEL PROTECTION (5mA) 2. GFCP FOR EQUIPMENT PROTECTION (30mA)								REMARKS: ELECTRICAL CONTRACTOR TO INSTALL TYPED PANEL SCHEDULE WITH ACCURATE DESCRIPTIONS										
CKT	DESCRIPTION			CKT NOTE	LOAD VA	LOAD AMPS	AMPS/ POLES	A	LOAD (VA) N/A		C	AMPS/ POLES	LOAD AMPS	LOAD VA	CKT NOTE	DESCRIPTION		CKT
1	SPARE				0.0	20	1	0				20	1	0.0		SPARE		2
3	SPARE				0.0	20	1				0	20	1	0.0		SPARE		4
5	SPARE				0.0	20	1	0				20	1	0.0		WEST RETAIL AREA RECEPTACLES		6
7	TRACK LIGHTING 2ND FLOOR				0.0	20	1				0	20	1	0.0		RETAIL MAIN LIGHTING/STAIR FAN		8
9	TRACK AND HALL LIGHTS				0.0	20	1	0				20	1	0.0		TRACK LIGHTS RETAIL		10
11	LOCKER/PUBLIC PATH/ LOW STAIR LIGHTS				0.0	20	1				0	20	1	0.0		TRACK LIGHTS RETAIL		12
13	PUBLIC BATH RECEPTACLES & HEATER				0.0	20	1	0				20	1	0.0		SPARE		14
15	EAST RETAIL AREA RECEPTACLES				0.0	20	1				0	20	1	0.0		SPARE		16
17	SPARE				0.0	20	1	0				20	1	0.0		SPARE		18
19	SPARE				0.0	20	1				0	20	1	0.0		SPARE		20
21	SPARE				0.0	20	1	0				20	1	0.0		SPARE		22
23	SPARE				0.0	20	1				0	20	1	0.0		SPARE		24
25	SPARE				0.0	20	1	0				20	1	0.0		SPARE		26
27	SPARE				0.0	20	1				0	20	1	0.0		SPARE		28
29	SPARE				0.0	20	1	0				20	1	0.0		SPARE		30
								0.0		0.0	VA							
								0.0		0.0	AMPS	0 TOTAL VA						

NEW PANEL: T-2A				PROJECT: GRACE SPA										
VOLTAGE: 240 / 120 V				1 PH	3 WIRE	AMPERE RATING: 125A WITH 125A MLO			MOUNTING: FLUSH					
BASIS OF DESIGN PANEL / TYPE				PANEL BOARD		NEMA ENCLOSURE TYPE: 1			PANEL AIC RATING: 10000 AIC					
CKT NOTES: 1. GFCI FOR PERSONNEL PROTECTION (5mA)				REMARKS: ELECTRICAL CONTRACTOR TO VERIFY ALL CIRCUITS PRIOR TO WORK										
CKT	DESCRIPTION	CKT NOTE	LOAD VA	LOAD AMPS	AMPS/ ROLES	A	LOAD (VA) NA	C	AMPS/ ROLES	LOAD AMPS	LOAD VA	CKT NOTE	DESCRIPTION	CKT
1	RECEPTACLES RR 109, TREATMENT 108		1440	12.0	20	1	2440		20	1	8.3	1000	RECEPTACLES SALON CHAIR 1	2
3	RECEPTACLES TREATMENT 107, HALL		1440	12.0	20	1		1980	20	1	4.5	540	RECEPTACLES SALON CHAIR 2	4
5	RECEPTACLES TREATMENT 106, RR 103		1440	12.0	20	1	1980		20	1	4.5	540	RECEPTACLES SALON CHAIR 3	6
7	RECEPTACLES SHAMPOO		1080	9.0	20	1		1080	30	2	0.0		SPARE	8
9	RECEPTACLES STORAGE/BREAK		360	3.0	20	1	360		**	*	0.0		SPARE	10
11	WASHER	1	1200	10.0	20	1		2800	20	1	13.3	1600	FIREPLACE POWER	12
13	RECEPTACLES STORAGE/BREAK		360	3.0	20	1	1335		20	1	8.1	975	LIGHTING - WAITING, SALON	14
15	RECEPTACLES TREATMENT ROOM 110		1080	9.0	20	1		1980	20	1	7.5	900	LIGHTING - NAILS, RESTROOM, STORAGE	16
17	RECEPTACLES TREATMENT ROOM 111		1440	12.0	20	1	3240		20	1	15.0	1800	LIGHTING - TREATMENT, HALL, RESTROOM	18
19	RECEPTACLES MANI/PEI		540	4.5	20	1		540	20	1	0.0		SPARE	20
21	RECEPTACLES MANI/PEI		360	3.0	20	1	360		20	1	0.0		SPARE	22
23	RECEPTACLES MANI/PEI		180	1.5	20	1		180	20	1	0.0		SPARE	24
25	RECEPTACLES RECEPTION		540	4.5	20	1	540		20	1	0.0		SPARE	26
27	RECEPTACLES SHAMPOO CHAIRS		540	4.5	20	1		540	20	1	0.0		SPARE	28
29	SPARE			0.0	20	1	0		20	1	0.0		SPARE	30
						10255.0		9100.0	VA					
						85.5		75.8	AMPS		19355 TOTAL VA			

NEW PANEL: T-2B										PROJECT: GRACE SPA											
VOLTAGE:			240 / 120 V			3 PH		4 WIRE		AMPERE RATING:			125A		WITH 125A		M.L.O.		MOUNTING: FLUSH		
BASIS OF DESIGN PANEL TYPE:						PANEL BOARD				NEMA ENCLOSURE TYPE:				1		PANEL AIC RATING: 10000 AIC					
CKT NOTES: 1. GFCI FOR PERSONNEL PROTECTION (5mA)										REMARKS: ELECTRICAL CONTRACTOR TO VERIFY ALL CIRCUITS PRIOR TO WORK  PANEL IS 240/120V 3 PHASE OPEN DELTA - LABEL IN ACCORDANCE WITH NEC 110.15											
CKT	DESCRIPTION		CKT NOTE	LOAD VA	LOAD AMPS	AMPS/ POLES	LOAD (VA)		A	C	AMPS/ POLES	LOAD/ AMPS	LOAD VA	CKT NOTE	DESCRIPTION						
1	COVE HEATERS (CH-1, CH-2)			1200	10.0	20 / 2	1907.2				20 / 2	5.9	707		AIR HANDLING UNIT (AHU-1)						
3	***			1200	10.0	** *	1907.2				** *	5.9	707		***						
5	COVE HEATER (CH-3)			600	5.0	20 / 2				600	50 / 2	0.0			CONDENSING UNIT (HP-1)						
7	***			600	5.0	** *	600				** *	0.0			***		NON-COINCIDENT				
9	COVE HEATERS (CH-4, CH-5)			1200	10.0	20 / 2	3200				30 / 2	16.7	2000	1	DRY ER						
11	***			1200	10.0	** *				3200	** *	16.7	2000	1	***						
13	SPARE				0.0	20 / 1	5280				60 / 3	44.0	5280		ELECTRIC DUCT HEATER (EDH-1)						
15	SPARE				0.0	20 / 1	5280				** *	44.0	5280								
17	SPARE				0.0	20 / 1				5280	** *	44.0	5280								
19	SPARE				0.0	20 / 1	899				15 / 2	7.5	899		HRV-1						
21	SPARE				0.0	20 / 1	899				** *	7.5	899								
23	SPARE				0.0	20 / 1				0	20 / 2	0.0			SPARE						
25	SPARE				0.0	20 / 1	0				** *	0.0			***						
27	SPARE				0.0	20 / 1	0				30 / 2	0.0			SPARE						
29	SPARE				0.0	20 / 1				0	** *	0.0									
						8686.2		11286.2		9080.0		VA									
						72.4		94.1		75.7		AMPS									
														17766 TOTAL VA							

ELECTRICAL LOAD SUMMARY (R-1)																
FEEDER	VOLTAGE	CONNECTED LOAD (KVA)										TOTAL CONNECTED LOAD		TOTAL DEMAND LOAD		
		LIGHTING	RECEP	MOTORS	KITCHEN	HVAC	ELEC HEAT	WATER HEAT	MISC	EXIST	KVA	AMPS	KVA	AMPS		
(EJR-1	120/208Y	0.0	0.0	0.0	0.0	0.0	0.0	0.0	0.0	44.5	44.5	123.6	44.5	123.6		
(EJR-1) X 125%	120/208Y									12.9	12.9	35.9	12.9	35.9		
NEW PANEL T-3	120/208Y	INCLUDED IN R-1 EXISTING DEMAND														
NEW PANEL T-2A	120/240	3.7	15.7	0.0	0.0	0.0	0.0	0.0	0.0	0.0	19.4	80.6	16.5	68.8		
NEW PANEL T-2B	120/240	0.0	0.0	0.0	0.0	3.2	21.8	0.0	4.0	0.0	29.1	121.1	29.1	121.1		
NEW PANEL T-C	120/240	INCLUDED IN R-1 EXISTING DEMAND														
TOTAL	120/208Y	3.7	15.7	0.0	0.0	3.2	21.8	0.0	4.0	57.4	105.8	294.0	103.9	288.6		

ELECTRICAL LOAD SUMMARY (T-1)														
FEEDER	VOLTAGE	CONNECTED LOAD (KVA)									TOTAL CONNECTED LOAD		TOTAL DEMAND LOAD	
		LIGHTING	RECEP	MOTORS	KITCHEN	HVAC	ELEC HEAT	WATER HEAT	MISC	EXIST	KVA	AMPS	KVA	AMPS
(E)T-1	120/208Y	0.0	0.0	0.0	0.0	0.0	0.0	0.0	0.0	31.5	31.5	87.5	31.5	87.5
(E)T-1 X 125%	120/208Y									7.9	7.9	21.9	7.9	21.9
TOTAL	120/208Y	0.0	0.0	0.0	0.0	0.0	0.0	0.0	0.0	39.4	39.4	109.4	39.4	109.4

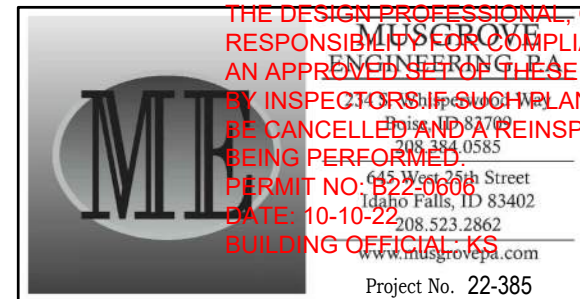

**TOWN OF JACKSON**

APPROVED FOR BUILDING CONSTRUCTION. ANY DEVIATIONS FROM APPROVED PLANS ARE SUBJECT TO PRIOR APPROVAL. REMOVAL OF THESE PLANS DOES NOT RELIEVE THE DESIGNER OR GENERAL CONTRACTOR OF RESPONSIBILITY FOR THE PROJECT.

**NORTHWORKS ARCHITECTS & PLANNERS**

RESPONSIBLE FOR COMPLIANCE WITH ALL APPLICABLE ORDINANCES AND REGULATIONS. AN APPROPRIATE FEE FOR PLANS IS TO BE PAID AT THE TIME OF SUBMITTAL TO WASHINGTON COUNTY, PENNSYLVANIA.

IF INSPECTORS FIND SUCH PLANS ARE NOT AVAILABLE ON SITE, ANY INSPECTION MAY BE CANCELLED AND A REINSPECTION CHARGE LEVIED PRIOR TO THE INSPECTION BEING PERFORMED.

HARSH NO. 12-223-55  
1000 N. High Street  
PO Box 653  
Jackson, WY 83402  
Phone 323 2862  
Fax 323 2863  
[www.nwks.com](http://www.nwks.com)


Project No. 22-35

185 E. Hansen Ave., PO Box 4027 Jackson, WY 83001  
T 208-201-5524 www.nwks.com

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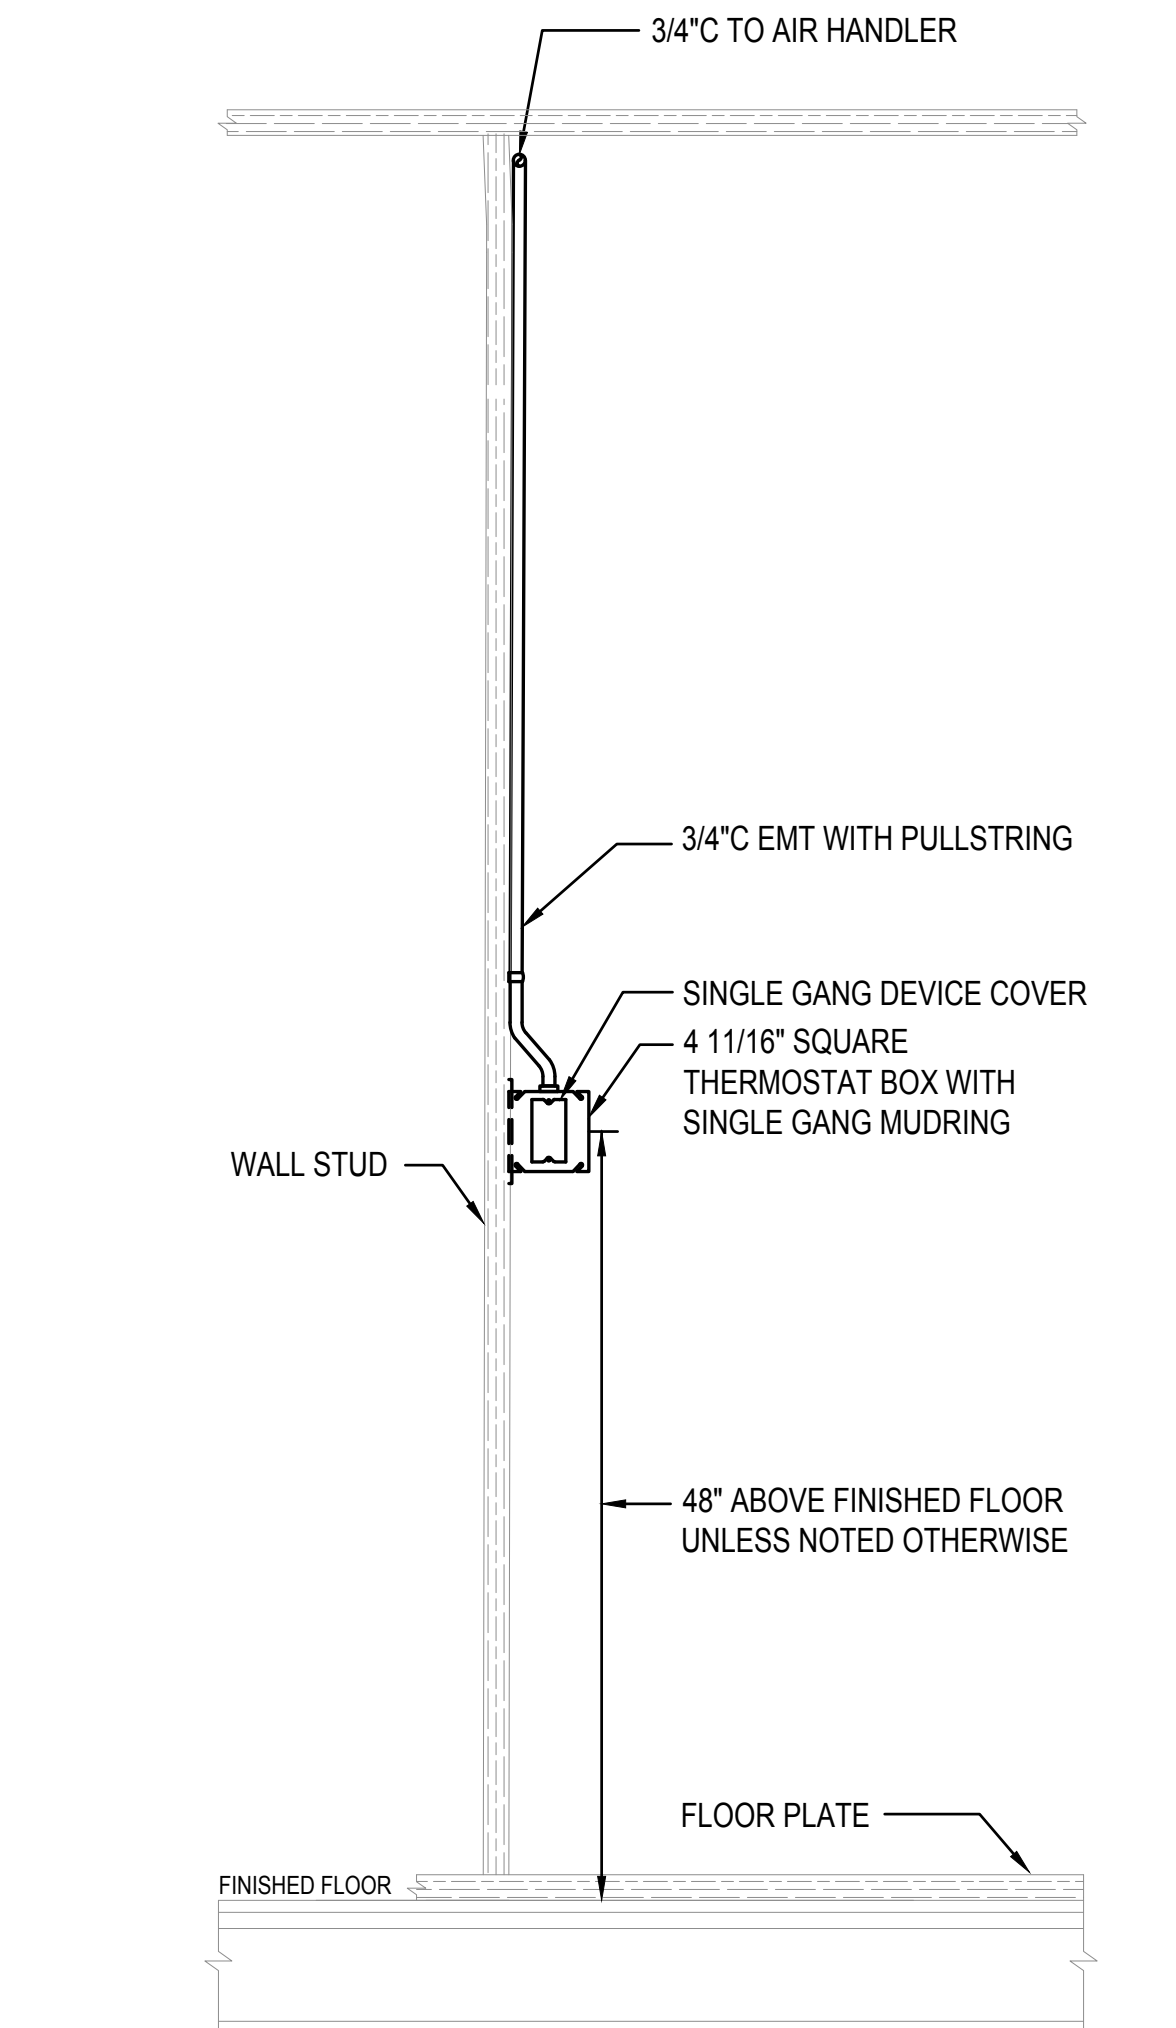
PROFESSIONAL SEAL

Project  
GRACE SPA


22385	Project No.
CJ	Drawn By
MNB	Checked By
Discipline	Drawing No.
E	4.00
Drawing Name	

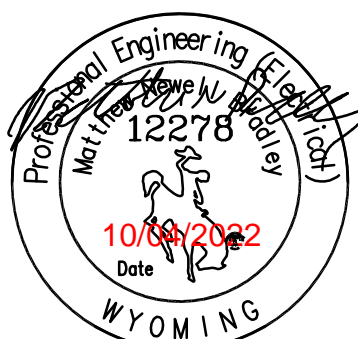EXISTING PANEL SCHEDULES






1 THRMOSTAT ROUGH-IN ELEVATION  
1" = 1'-0"

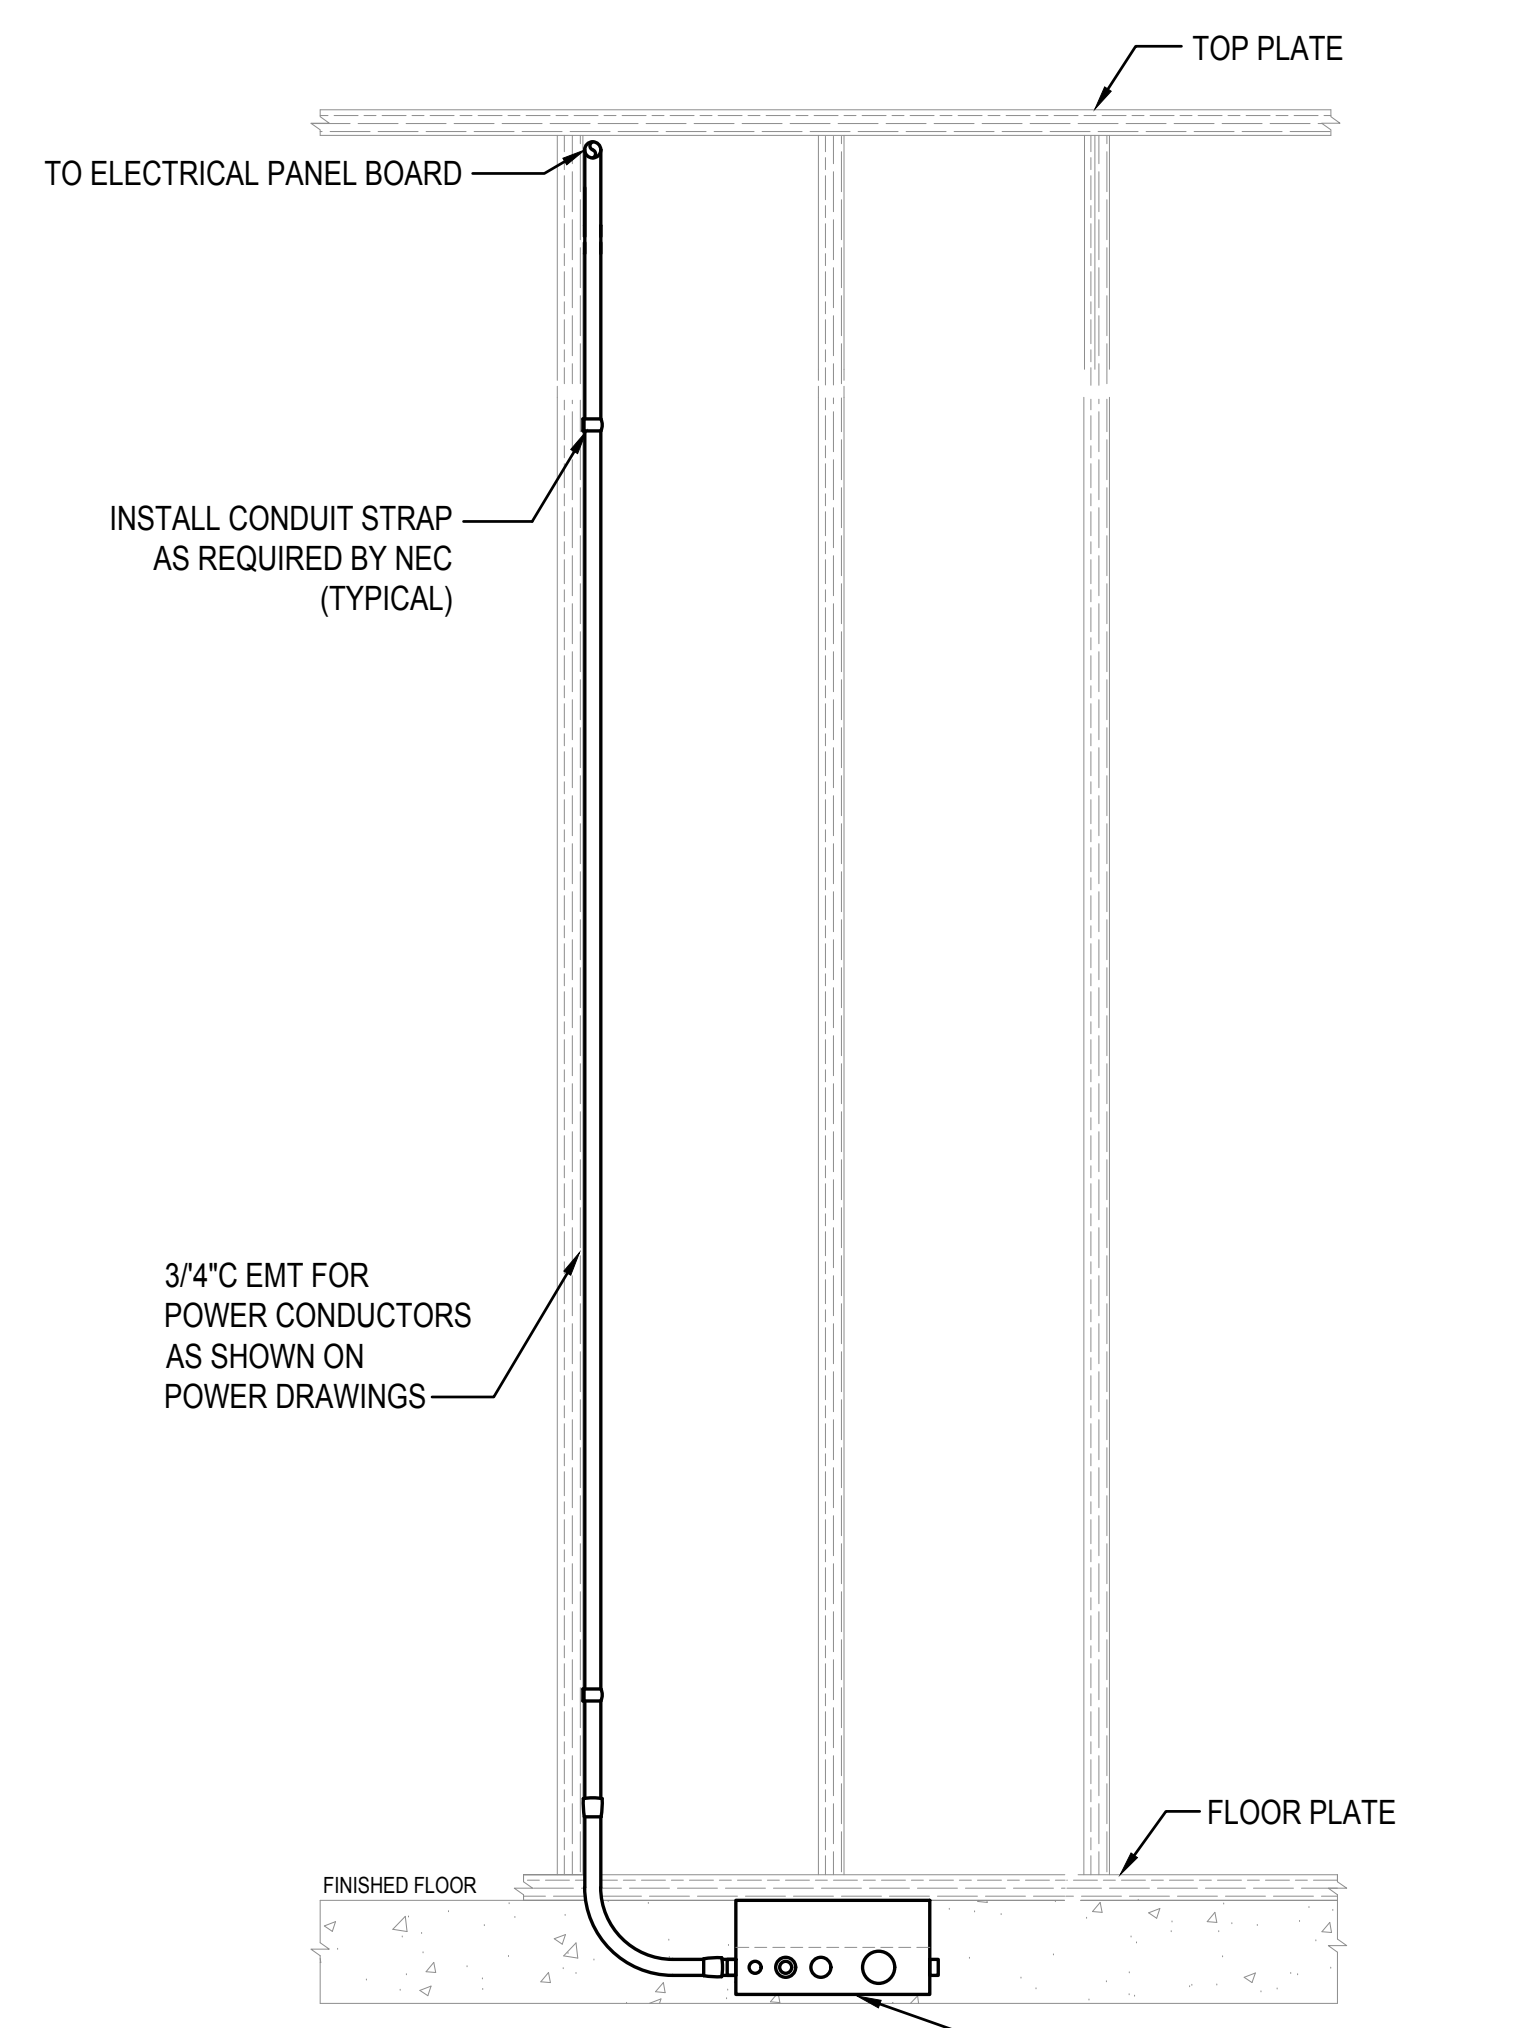

2 POWER FLOOR BOX ROUGH-IN ELEVATION  
1" = 1'-0"

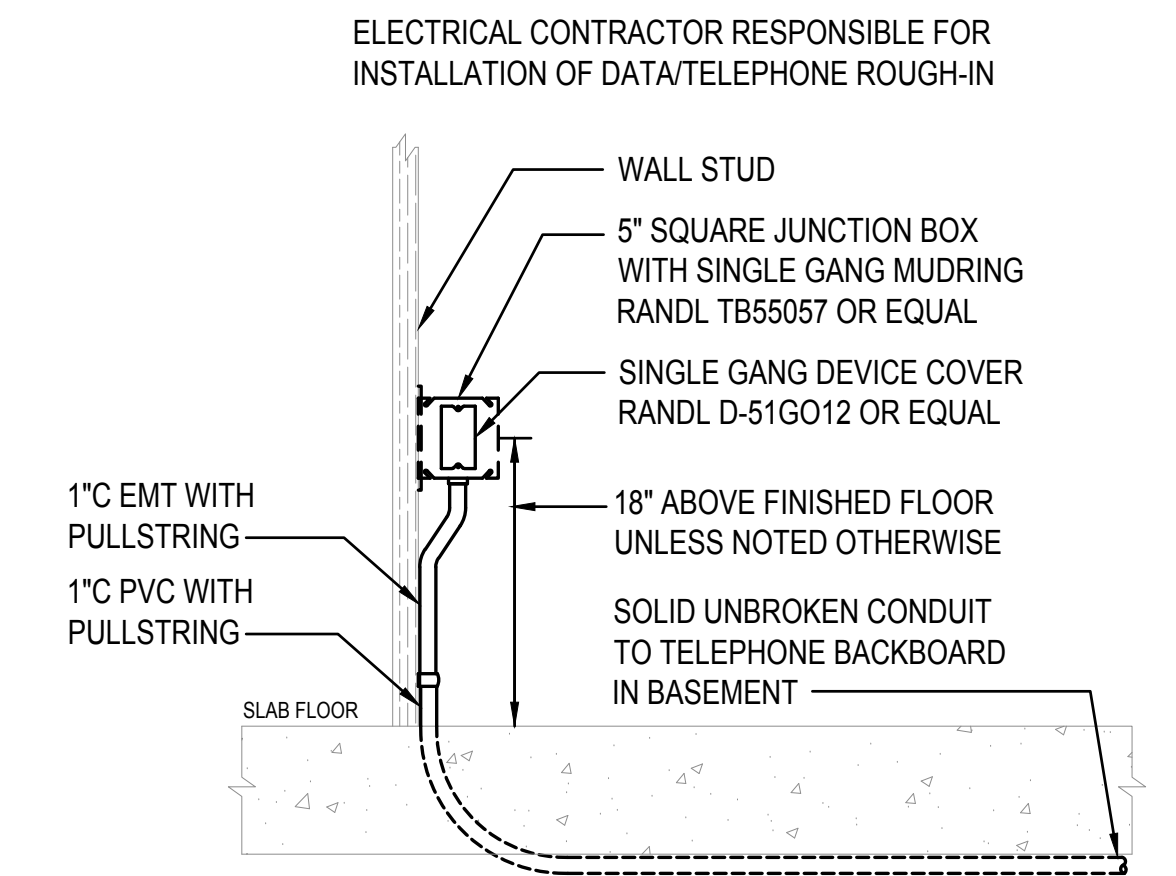

3 DATA TELEPHONE FLOOR FEED ROUGH-IN ELEVATION  
1" = 1'-0"

LIGHTING FIXTURE SCHEDULE (22-385)						
TYPE	DESCRIPTION	MTG.	LAMPS	WATTS	MFG. & CATALOG NUMBER	OR EQUAL BY
A	6" CYLINDAR PENDANT WITH LED LAMP SATCO S9704	PENDANT	LED 3000K	10	VOLUME LIGHTING NO. V9606-5 SATCO NO: S9704	LIGHTOLIER METALUX H.E. WILLIAMS
P1	HATTON 2 LIGHT PENDANT WITH LED LAMP SATCO S21351	PENDANT	LED 3000K	16	KICHLER NO. 52258BK SATCO NO: S21351	LIGHTOLIER METALUX H.E. WILLIAMS
P2	RUMER 1 LIGHT PENDANT WITH LED LAMP SATCO S11358	PENDANT	LED 3000K	11	KICHLER NO. 43589NBR SATCO NO: S11358	LIGHTOLIER METALUX H.E. WILLIAMS
P3	LED PENDANT FINISH BY ARCHITECT	PENDANT	LED 3000K	17	KICHLER NO. 83854XXXXX	LIGHTOLIER METALUX H.E. WILLIAMS
S1	HATTON 2 LIGHT SCONCE WITH LED LAMP SATCO S21351	SCONCE	LED 3000K	16	KICHLER NO. 52259BK SATCO NO: S21351	LIGHTOLIER METALUX H.E. WILLIAMS
E	INTEGRATED EXIT/UNIT COMBO FIXTURE GREEN EXIT LED	SURFACE	LED	2.32	LITHONIA NO. ECBG LED M6	LIGHTOLIER METALUX H.E. WILLIAMS
F	EXTERIOR EGRESS LIGHT COLD WEATHER BATTERY WET LOCATION LISTED, DARK BRONZE	SURFACE	LED	1	LITHONIA NO. AFO-DB-MVOLT-N-SD-CW	LIGHTOLIER METALUX H.E. WILLIAMS
LIGHTING FIXTURE SCHEDULE NOTES: 1 SUBSTITUTIONS WILL BE ALLOWED IF SUBMITTED PRIOR TO BID DATE BY THE GREATER OF: 7 BUSINESS DAYS OR THE TIME PERIOD SPECIFIED BY DIVISION 1 SPECIFICATIONS, AND IF DEEMED EQUAL BY THE ENGINEER. THE CONTRACTOR IS RESPONSIBLE FOR ENSURING SUBSTITUTED FIXTURES MEET OR EXCEED THE SPECIFICATIONS OF THE FIXTURES SPECIFIED.						

SWITCH AND OCCUPANCY SENSOR LEGEND	
S051	OCCUPANCY SENSOR - WALL MOUNT, SINGLE TECHNOLOGY, 120-277V, SINGLE POLE, MULTI-WAY SENSOR SWITCH WSXA-MWO-XX OR EQUAL
S052	OCCUPANCY SENSOR - WALL MOUNT, DUAL TECHNOLOGY, DIMMING, 120-277V, SINGLE POLE, MULTI-WAY SENSOR SWITCH WSXA-MWO-PDT-D-XX OR EQUAL
S0	DIMMING SWITCH - WALL MOUNT, 120V, LED, ELV ON/OFF/SIDE DIMMER SWITCH SYNERGY ISD-400-ELV-120-XX OR EQUAL
XX=VERIFY COLOR WITH ARCHITECT PRIOR TO ORDER	
EQUAL PRODUCTS FROM WATTSTOPER, LUTRON, LEGRAND, AND EATON WILL BE ACCEPTED	

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185 E. Hansen Ave, PO Box 4027  
T 208-201-5324

Jackson, WY 83001  
www.nwks.com

ISSUED DATE

ISSUED FOR

PROFESSIONAL SEAL

Professional Engineering Seal  
12278  
10/18/2022  
WYOMING

Project  
GRACE SPA

22385	Project No.
CJ	Drawn By
MNB	Checked By
Discipline	Drawing No.
E	5.00
Drawing Name	DETAILS

TOWN OF JACKSON  
APPROVED FOR BUILDING CONSTRUCTION. ANY DEVIATIONS FROM APPROVED PLANS  
ARE SUBJECT TO PRIOR APPROVAL. APPROVAL OF THESE PLANS DOES NOT RELIEVE  
THE DESIGN PROFESSIONAL GENERAL CONTRACTOR OR SUBCONTRACTOR OF  
RESPONSIBILITY FOR COMPLIANCE WITH ALL APPLICABLE CODES, ORDINANCES, AND  
ANY APPLICABLE PERMITS. THE DESIGN PROFESSIONAL GENERAL CONTRACTOR  
OR SUBCONTRACTOR SHALL BE RESPONSIBLE FOR OBTAINING ALL NECESSARY  
PERMITS AND INSPECTIONS. IF SUCH PLANS ARE NOT AVAILABLE ON SITE, ANY INSPECTION MAY  
BE CANCELLED AND A REINSPECTION CHARGE LEVIED PRIOR TO THE INSPECTION  
BEING PERFORMED.  
PERMIT NO. 22-385  
PROJECT NO. 22-385  
BUILDING OFFICE

Development of a new house, hotel, or commercial space generates the need for employees. The construction workforce builds the space, the commercial workforce or residential service workforce works in the space, and first responders are needed to protect the space. Only about 27% of the employees generated by development can afford housing in the community, but the community's "community first" character goal is that 65% of employees live locally. To bridge this affordability gap, each development is required to include affordable workforce housing proportional to the employees it generates. These housing mitigation requirements are established in Division 6.3 of the Land Development Regulations. This worksheet is intended to assist in meeting the requirements for a project. However, an error in the worksheet does not amend the actual standard; if you find an error please notify the Planning Department. Fill in the highlighted cells, all the other cells will autopopulate.

Calculating the Requirement (Sec. 6.3.2 & 6.3.3)

Step 1: Location

Town of Jackson

The applicable regulations vary by jurisdiction please identify the location of your project using the above dropdown options.

The required housing is based on the existing and proposed use of the site. Step 2 is to enter the existing use and Step 3 is to enter the proposed use. Section 6.3.2 of the LDRs establishes the applicability of the affordable workforce housing standards and Section 6.3.3 establishes the specifics on calculation of the requirement. Enter each use in its own row, add rows if needed. If a building has multiple units with the same use, describe each unit in its own row. (For example: if a duplex is composed of a 2,300 sf attached unit and a 1,700 sf attached unit, put each unit in its own row do not put in 4,000 sf of attached single-family.) If a unit type (e.g. apartment floor plan, or commercial tenant space) is replicated exactly multiple times, you may use the "Use Quantity" column to avoid adding multiple rows.

Step 2: Existing Development

Housing is only required for new development. Please describe the existing use of the site so that it can be credited from the housing requirement. The definition of existing use is Section 6.3.2.A.1 of the LDRs. Generally, the existing use to enter is the use with the highest housing requirement that either existed in 1995, or has been permitted since 1995. Please attach proof of existence.

Existing Use (Sec. 6.3.2.A)	Housing Requirement (Sec. 6.3.3.A)	Use Size: bedrooms	Use Size: habitable sf	Use Quantity	Housing Required
Service	0.000216*sf	0	1748	1	0.377

Existing Workforce Housing Credit0.377

Step 3: Proposed Development

Please describe the proposed use of the site to determine if affordable workforce housing is required as part of the development. Describe the end result of the proposed development. (For example: in the case of an addition do not enter the square footage of the addition, enter the size of the unit upon completion of the addition.)

Proposed Use	Housing Requirement (Sec. 6.3.3.A)	Use Size: bedrooms	Use Size: habitable sf	Use Quantity	Housing Required
service	0.000216*sf	0	1748	1	0.377

Affordable Workforce Housing Required:0.000 unitsFee-in-Lieu Amount:\$-

If the amount of required affordable workforce housing is less than one unit, you may pay the above fee in-lieu of providing the required housing. If you elect to pay the fee, your Housing Mitgation Plan is complete. If the requirement is greater than one unit, or you would like to provide a unit to meet the requirement, please proceed to the Unit Type Sheet.

## Housing Mitigation Plan

update

Page 2

## Type of Units Required (Sec. 6.3.4)

## Step 4: Type of Units Required

The LDRs include a schedule for how many units have to be affordable to each income range and how many units have to have 1, 2, or 3 bedrooms. LDRs also allow for adjustment, subject to approval by the Housing Director. To propose an adjusted allocation, change the values in the gold cells. A customized allocation must meet the customization rules provided. If a rule is violated, the cell will turn red. See also Section 6.3.4 of the LDRs.

Affordability	LDR Schedule	Proposed	Custom %	Customization Rule
Units Affordable to Households making 50% Median Income	0.000	0.000	#DIV/0!	Custom % shall be >=
Units Affordable to Households making 80% Median Income	0.000	0.000	#DIV/0!	Custom % shall be >=
Units Affordable to Households making 120% Median Income	0.000	0.000	#DIV/0!	Custom % shall be >=
Workforce Units	0.000	0.000	#DIV/0!	Custom % shall be >=
Total	0.000	0.000	Proposed total shall be >=	

Bedroom Mix	1 Bed/Studio	2 Bedroom	3 Bedroom	Total Units	Total Employees Housed	Customization Rule
LDR Schedule	0.000	0.000	0.000	0.000	0.000	The Proposed total shall be less than or equal to the Schedule total.
Proposed Allocation	0.000	0.000	0.000	0.000	0.000	
Employees per Unit per LDRs	1.45	2.00	2.10	1.80		

## Step 5: Distribution of Affordability by Unit Size

The bedroom mix must be proportionally distributed among the affordability mix. If you modify the distribution (gold cells) the totals must match your allocation totals (they will turn red if they do not). A customized distribution should be within 1 (rounded up or down). An even distribution displayed (it will turn red if it is not). See also Section 6.3.4 of the LDRs.

Requirement Distribution					Even Distribution		
	1 Bed/Studio	2 Bedroom	3 Bedroom	Total	1 Bed/Studio	2 Bedroom	3 Bedroom
Affordable to 50% Median Income	0.000	0.000	0.000	0.000	0.000	0.000	0.000
Affordable to 80% Median Income	0.000	0.000	0.000	0.000	0.000	0.000	0.000
Affordable to 120% Median Income	0.000	0.000	0.000	0.000	0.000	0.000	0.000
Workforce Restriction	0.000	0.000	0.000	0.000	0.000	0.000	0.000
Total	0.000	0.000	0.000				

Once you have determined the proposed distribution please fill out the [Method Sheet](#) regarding how the required housing will be provided.

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all be $\geq 25\%$
all be $\geq 19\%$
all be $< 43\%$
all be $< 13\%$
Required

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## Housing Mitigation Plan

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Page 3

## Method for Providing the Required Units (Sec. 6.3.5)

## Step 6: Method of Housing Unit Provision

The LDRs require that unless impractical, any housing requirement of 1 unit or greater be provided through construction of housing. If impractical, the units may be provided by dedication of land, use of a banked unit, or restriction of an existing unit. Only as a last option shall a fee be paid. The distribution of housing types selected in Step 5 is reflected in the chart below. The default method for providing a whole housing unit is on-site construction. If you would like to propose an alternate method, or provide the requirement through various methods, adjust the gold cells. A red cell indicates the adjustment does not match Step 5. The instructions cell indicates the standards that apply to each method. In addition, each unit shall comply with the Jackson Teton/County Housing Department Rules and Regulations. Response to the applicable standards shall be provided with this Housing Mitigation Plan. The in-lieu fee will calculate.

Unit Type	Units	Method	Instructions
		Fee In-Lieu	please document compliance with Sec. 6.3.5.C
		Fee In-Lieu	please document compliance with Sec. 6.3.5.C
		Fee In-Lieu	please document compliance with Sec. 6.3.5.C
		Fee In-Lieu	please document compliance with Sec. 6.3.5.C
<b>Total Units:</b>	<b>0.000</b>	<b>Fee In-Lieu:</b>	<b>\$0.00</b>

## Step 7: Attachments

Please attach to this worksheet any demonstration of existence, independent calculation, rationale for adjustment of unit type, rationale for the proposed method, documentation of the proposed method that is required by Division 6.3. Please contact the Planning Department with any questions. Information regarding the source of the numbers in this worksheet is available in the Source Sheets.



	Office	Retail	Restaurant Bar
Nexus Study Calculation (Or Subsequent Codified Independent Calculation)			
Construction			
employees per 1,000 sf	1.234	1.234	1.234
sf per room			
Length of Construction Career	30	30	30
employees per 1,000 sf/room	0.041	0.041	0.041
employees per unit	1.774	1.774	1.774
employees who can afford	28.87%	28.87%	28.87%
units per 1,000 sf/room	0.016	0.016	0.016
Post-Construction			
employees per 1,000 sf/room	1.598	1.202	3.911
employees per unit	1.678	1.706	2
Employees who can afford	33.14%	21.30%	19.65%
units per 1,000 sf/room	0.637	0.554	1.571
Fire/EMS			
Fire/EMS employees per 1000 sf	0.00100	0.00100	0.00100
employees per unit	1.797	1.797	1.797
employees who can afford	25.56%	25.56%	25.56%
Fire/EMS units per 1000 sf	0.00042	0.00042	0.00042
Law Enforcement			
Law employees per 1000 sf	0.00301	0.00301	0.00301
employees per unit	1.797	1.797	1.797
employees who can afford	27.09%	27.09%	27.09%
Law units per 1000 sf	0.00122	0.00122	0.00122
Total			
Employees per 1000 sf/room	1.643	1.247	3.956
units per 1,000 sf/room	0.655	0.573	1.589
2018 Policy Decision Upon Adoption + 2020 Policy Update			
Town			
Town Yearround mitigation "rate"	27.5%	27.5%	27.5%
Town Reduction factor	0.38	0.38	0.38
<b>Town Required units per 1,000 sf/room</b>	<b>0.247</b>	<b>0.216</b>	<b>0.599</b>
County			
County Yearround mitigation "rate"	24%	24%	24%
County Reduction factor	0.33	0.33	0.33
<b>County Required units per 1,000 sf/room</b>	<b>0.215</b>	<b>0.188</b>	<b>0.523</b>

Mini Storage	Industrial	Institutional	Lodging	Residential
0.514	0.514	0.927	1.234 900	1.234
30	30	30	30	30
0.017	0.017	0.031	0.037	0.041
1.774	1.774	1.774	1.774	1.774
28.87%	28.87%	28.87%	28.87%	28.87%
0.007	0.007	0.012	0.015	0.016
0.02	0.71	1.598	0.487	
1.652	1.652	1.678	2	1.713
26.08%	26.08%	28.18%	22.87%	21.26%
0.009	0.318	0.684	0.188	2.176
0.00100	0.00100	0.00100	0.00100	0.00033
1.797	1.797	1.797	1.797	1.797
25.56%	25.56%	25.56%	25.56%	25.56%
0.00042	0.00042	0.00042	0.00042	0.00014
0.00301	0.00301	0.00301	0.00301	0.00107
1.797	1.797	1.797	1.797	1.797
27.09%	27.09%	27.09%	27.09%	27.09%
0.00122	0.00122	0.00122	0.00122	0.00043
0.041	0.731	1.633	0.528	0.043
0.017	0.326	0.698	0.204	0.017
27.5%	27.5%	27.5%	37%	73%
0.38	0.38	0.38	0.50	1.00
<b>0.007</b>	<b>0.123</b>	<b>0.263</b>	<b>0.102</b>	<b>0.017</b>
24%	24%	24%	37%	73%
0.33	0.33	0.33	0.50	1.00
<b>0.006</b>	<b>0.107</b>	<b>0.229</b>	<b>0.102</b>	<b>0.017</b>

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# HOUSEHOLD INCOME IN THE PAST 12 MONTHS (IN 2016 INFLATION-ADJUSTED DOLLARS)

Universe: Households

2012-2016 American Community Survey 5-Year Estimates

**Teton County, Wyoming**

HMI ~ \$75,000

	Estimate		
Total:	8,576		
Less than \$10,000	196		
\$10,000 to \$14,999	171		
\$15,000 to \$19,999	191		
\$20,000 to \$24,999	561		
\$25,000 to \$29,999	208		
\$30,000 to \$34,999	203		
\$35,000 to \$39,999	340		
\$35,000 - \$37,499	170	20%	25%
\$37,500 - \$39,999	170		
\$40,000 to \$44,999	451		
\$45,000 to \$49,999	197		
\$50,000 to \$59,999	510	15%	19%
\$60,000 to \$74,999	1,231		
\$75,000 to \$99,999	1,226		
\$100,000 to \$124,999	862		
\$100,000 - \$104,999	172.4		
\$105,000 - \$109,999	172.4		
\$110,000 - \$114,999	172.4	35%	43%
\$115,000 - \$119,999	172.4		
\$120,000 - \$124,999	172.4		
\$125,000 to \$149,999	573	11%	13%
\$150,000 to \$199,999	386	19%	
\$200,000 or more	1,270		
Median = \$75,594			

## B08202: HOUSEHOLD SIZE BY NUMBER OF WORKERS IN HOUSEHOLD - Universe: Households

2012-2016 American Community Survey 5-Year Estimates

Teton County, Wyoming

	Estimate		
Total:	8,576		
No workers	1,700		
1 worker	2,935		
2 workers	3,238		
3 or more workers	703		
1-person household:	2,573		
No workers	935		
1 worker	1,638		
2-person household:	3,203		
No workers	639		
1 worker	771		
2 workers	1,793		
		Assumed E Allocation	
		1 Bedroom	1.426702 0.428571
		2 Bedroom	1.994506 0.428571

3-person household:	1,413	3 Bedroom	2.092428	0.142857
No workers	0			
1 worker	251			1.76515
2 workers	759			
3 workers	403			
4-or-more-person household:	1,387			
No workers	126			
1 worker	275			
2 workers	686			
3 or more workers	300			

**Cost per Livable sf** (based on most recent projects currently being developed, see equation)

\$674.29

Most Recent Housing Department  
Land

174 N. King St.	\$	2,000,000
Redmond Street P	\$	3,645,000
440 W. Kelly	\$	1,703,416

**Median Income** (based on most recent HUD Family Median Income applied to housing department in-take data based on Rules and Regulations occupan

	1 bed	2 bed	3 bed
50%	\$ 38,016.91	\$ 48,238.40	\$ 51,707.96
80%	\$ 60,827.05	\$ 77,181.44	\$ 82,732.73
120%	\$ 91,240.57	\$ 115,772.16	\$ 124,099.10
200%	\$ 152,067.62	\$ 192,953.60	\$ 206,831.84

Median Income by Persons in Household (HUD)

1	\$	71,540
2	\$	81,760
3	\$	91,980
4	\$	102,200
5	\$	110,376
6	\$	118,552
7	\$	126,728

**Average Livable Size** (set by policy in LDRs, recent Housing Department developments at right for reference)

1 bed	2 bed	3 bed
	650	900
		1150

Unit sizes in most

174 N. King St
Redmond Street
Grove Phase 1
440 W. Kelly

**Max Rental Rate** (based on Rules and Regulations that rent shall be based on low end of range spending 30% of income on rent, including utilities)

	1 bed	2 bed	3 bed
50%	\$ 2,043.04	\$ 3,882.91	\$ 4,507.43
80%	\$ 6,605.07	\$ 9,671.52	\$ 10,712.39
120%	\$ 13,448.11	\$ 18,354.43	\$ 20,019.82
200%	\$ 22,572.17	\$ 29,931.65	\$ 32,429.73

Annual Utilities/HOA (estimate from Housing Departn

\$	4,800
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**Cap Rate** (set by policy in LDRs based on reasonable industry standard)



8%

**Maximum Sales Price** (based on Rules and Regulations that sales price shall be based on the middle of the range and use the mortgage terms at right)

	1 bed	2 bed	3 bed
50%	\$ 79,182.46	\$ 100,472.02	\$ 107,698.49
80%	\$ 171,562.00	\$ 217,689.38	\$ 233,346.74
120%	\$ 263,941.55	\$ 334,906.73	\$ 358,994.98
200%	\$ 422,306.47	\$ 535,850.77	\$ 574,391.97

22%	percent of income toward mortgage
5%	percent down
30	mortgage term
5%	20-year average interest rate

**Fee In-Lieu** (based on 6.3.4.B.1.a-b that the lower income ranges must be rental and assuming the higher ranges will be sold)

	1 bed	2 bed	3 bed
50%	\$ 412,749.72	\$ 558,323.58	\$ 719,089.29
80%	\$ 355,724.36	\$ 485,965.98	\$ 641,527.35
120%	\$ 174,346.22	\$ 271,953.24	\$ 416,437.21
200%	\$ 15,981.29	\$ 71,009.20	\$ 201,040.22

1 bed, < 50% Me	\$ 412,749.72
2 bed, < 50% Me	\$ 558,323.58
3 bed, < 50% Me	\$ 719,089.29
1 bed, < 80% Me	\$ 355,724.36
2 bed, < 80% Me	\$ 485,965.98
3 bed, < 80% Me	\$ 641,527.35
1 bed, < 120% M	\$ 174,346.22
2 bed, < 120% M	\$ 271,953.24
3 bed, < 120% M	\$ 416,437.21
1 bed, Workforce	\$ 15,981.29
2 bed, Workforce	\$ 71,009.20
3 bed, Workforce	\$ 201,040.22

developments (source: Housing Department)

Construction	Gross sf	Livable sf	Units	Gross/Unit	Livable/Unit	Gross/Livable	Land/Gross
\$ 14,000,000	31,531	21,286	30	1,051	710	1.48	\$ 60
\$ 9,255,000	35,078	18,645	26	1,349	717	1.88	\$ 104
\$ 3,884,688	12,000	10,000	16	750	625	1.20	\$ 142
				1,092	693	1.57	\$ 91

icy requirements)

Occupancy standards in Rules and Regulations

Bedrooms	Heads	Dependents
1	1 or 2	0 or 1
2	1 or 2	1+
3	1 or 2	2+

Housing Department Applications as of

	Dependants	
	0	1
Heads		
1	460	62
2	201	98

: recent Housing Department developments (source: Housing Department)

Studio	1 Bed	2 bed	3 bed
395	790	950	
495	588	1081	
535	705	928	
	500		1100

ment)



Construct/Gross    Total/Gross

\$	419	\$	478	Land was purchased in 2010, \$2,000,000 is the estimated value in 2018 based on comps, gross sf for land cost per gr
\$	264	\$	368	Land was purchased in 2014 for \$3,645,000, estimated value to day is about \$4.5M.
\$	324	\$	466	
	337	\$	428	

6/20/2019

2	3	4	5
28	11	2	0
106	38	6	4





ross sf includes 1915 sf of retail